The National Productivity Organization



BID BULLETIN No.4

22 August 2025 (Friday)

BIDDING NO.:	Title/Description:
IB25-414804-01	"ONE (1) LOT LUMP SUM CONTRACT FOR THE
APPROVED BUDGET CEILING (ABC):	COMPLETION OF UNFINISHED WORKS FOR THE
PHP1,740,000,000.00	CONSTRUCTION OF THE FOURTEEN-STOREY NEW TRAINING
Date of Pre-BID Conference	BUILDING, SITE DEVELOPMENT, AND VARIOUS SITE
	IMPROVEMENTS, INCLUDING SUPPLY AND INSTALLATION
29 July 2025 (Tue); 1:00 PM	OF DESIGN FIT-OUTS, FURNISHINGS, AND FIXTURES AT THE
	DAP CONFERENCE CENTER IN TAGAYTAY CITY"

This Bid Bulletin No. 04 is issued to clarify items and provisions in the Official Bidding Documents (OBD) for the above-stated project for the information of all concerned, as approved by the BAC and TWG. Accordingly, this shall form an integral part of the OBD.

1. On the queries of **MILLENNIUM ERECTORS CORPORATION**, the following are the clarifications/answers:

Reference	QUERIES	Responses/Clarifications			
Architectural	Provide details for Sun Deck.	Refer to Drawing Sheets Nos.:			
Plans		a. A1-7e;			
		b. A1-7I;			
		c. A1-8e;			
		d. A1-14a; and			
		e. FFE-1e.			
Structural	2. Provide SOG Details of	Refer to Drawing Sheets Nos.:			
Plans	Engineering Building.	a. A2-1k;			
		b. S-1;			
		c. S-1a; and			
		d. S-2.			
Structural Plans	3. Provide SOG details of receiver area in Main Building.	Refer to Drawing Sheets Nos. S-1, and S-40.			
Structural Plans	Provide Structural Details of Retaining Wall and Perimeter	Refer to Updated Drawing Sheets Nos.:			
	Fence as per BOQ item 32.5.	a. A0-1b Site Development Plan;			
		b. A0-1c Building Site Development Plan;			
		c. A0-1d Site Blow Up Plan;			
		d. S2-2 Perimeter Fence Layout & Details; and			
		e. S-10 Fence Details.			
Specialties	5. Provide the Drawing & Details	Refer to Drawing Sheets Nos.:			
	for all Scope under Div. 10.	a. A1-5l;			
		b. A1-5m;			
		c. A1-10a to A1-10s; and			
		d. A1-13a to A1-13k.			

shall attach clear and readable

Reference **QUERIES** Responses/Clarifications Plumbina 6. Provide the Drawing Plan for For STP Plumbing Plans, refer to: **Plans** STP Automation System for a. P0-2 Site Drainage Distribution Sewage Treatment Plant. Layout with STP; b. P6-1a STP Plans & Sections; c. P6-1b STP Air Diffuser and Waterline Layout; d. P6-1c STP Air Line Layout and Section; and e. P6-1d STP Equipment Layout. For the Design Criteria and STP Process Flow, refer to Annex "A" attached to this Bid Bulletin. The winning Bidder shall nominate three possible suppliers of automation equipment for the New STP, and shall be compatible with the existing STP equipment of DAPCC facility, for approval of the DAP. Electrical already 400V Not yet available. This is included in there 3Ø 7. Is tapping point service within the the Bidders' Scope of Work, refer to **Plans** OBD Section VI, Item No. 2.2.5 for project site? Electrical Works. Electrical 8. Confirm if a 400V, 3Ø tapping Not yet available. This is included in **Plans** point is already available within the Bidders' Scope of Work, refer to the project site. OBD Section VI, Item No. 2.2.5 for Electrical Works. General As attachment requirements for The required attachments for Form 1: the Bidder's Ongoing Projects, Bidders' Statement of All Ongoing Requirements it is stated that we must provide government and private contracts, including contracts awarded but not NOA, NTP and Contract. Most Private Owner's/Client does not yet started (if any), which is to be marked as "T07" of the Technical provide complete set of the documents. We are usually Documents, are hereby amended as provided just the Purchase follows: Order (PO) or only NTP/NOA a. For contract/s awarded but not yet not all of the documents. May started, Bidders shall attach clear we kindly asked if we can and readable copies of any of the provide just either one (1) of the following documents: required attachments. Notice of Award; Notice to Proceed; Contract/s for the Project/s; or, Purchase Order. b. For ongoing contract/s, Bidders

p.3/9

Reference	QUERIES	Responses/Clarifications
		 copies of the following: Purchase Order/s or Contract/s for the Project/s; and Certified True Copy of the "Certificate of Work Accomplishment" signed by the Project Owner or his/her Authorized Representatives for all ongoing contracts.
Architectural Plans	10. Kindly provide the following wall details (at 2 nd Floor): a. WF-19d b. WF-20d c. WF-21d	Refer to Drawing Sheet No. A1-22c.
General Requirements	11. As part of the Technical Requirements it is stated that it is required to provide CPES rating or similar performance evaluation documents in case of contracts with private sectors for completed projects in the last 5 years. For the said "other similar performance evaluation documents" does this refer to Certificate of Completion or Certificate of Acceptance?	The following are acceptable documents as equivalent to CPES rating: a. Bidder's Performance Evaluation Form reflecting a "satisfactory" works done to be signed by the Project Owner or his/her Authorized Representative for the completed project. b. Certificate of Completion stating that the Bidder has "satisfactory" completed works/contract signed by the Project Owner or his/her Authorized Representative for the completed project.

2. On the queries of **A.M. ORETA & CO., INC.**, the following are the clarifications/answers:

Reference	QUERIES	Responses/Clarifications
Landscape	1. Lower Hardscapes	Refer to:
Plans	 Confirm the types and sizes of pavers to be used under the "Concrete Paving" 	a. Drawing Sheet No. 01 LGF-LDP-01 for landscape development plan; and
	scope; and,	b. Technical Specifications (Part 3),
	 Specify the size of the pebbles intended for the "Pebble Washout Finish". 	under Division 32, Sections 32 90 00A and 32 90 00B for planting softscapes and hardscapes.
Landscape	2. Upper Floor Hardscapes:	Refer to Drawing Sheets Nos.:
Plans	Type and size of pavers	a. 03 LGF-MP-01;
	specified for the "Paved	b. 09 LGF-WPD-01; and
	Areas (Paver Blocks)" and also the size of G.I Pipes and Pots?	c. 15 4F-MP-01.



Reference	QUERIES	Responses/Clarifications
	 Clarification on what is specifically meant by "quick coupler" in this context. 	It is meant for convenient water access, efficient connection and disconnection of irrigation lines.
Landscape Plans	3. For the concreting works of the jogging paths, may we request details on the required thickness and other relevant specifications?	Refer to the Updated Drawing Sheets Nos.: a. 05 LGF-SE-01 Section Elevation; b. 05 LGF-SE-02 Section Elevation; and c. 05 LGF-SE-03 Section Elevation.
Landscape Plans	4. With regard to the Artificial Turf Area, our team would like to confirm whether the artificial turf will already be in place, and if our scope will be limited to the installation of shrubs, garden soil, gravel, and related materials.	Yes, it will be in place. But it will not be limited to the installation of shrubs, garden soil, gravel and related materials. For the complete scope for landscaping works, refer to: a. Construction Plans / Drawings for Landscape; b. Bill of Quantities under Division 32 — Exterior Improvements; and c. Technical Specifications (Part 3) under Division 32, Sections 32 90 00A and 32 90 00B for planting softscapes and hardscapes.
Architectural Plans	5. What is the standard font style requirements for Signages?	The standard font style shall be Helvetica Neue. For further details, refer to: a. Drawing Sheets Nos. A1-13j to A1-13k; and b. Technical Specifications (Part 1) under Division 10 for Specialties, Section 10 06 10.16 for the interior signage.
Architectural Plans	Detailed drawing or high resolution files for Signages.	Refer to Drawing Sheets Nos. A1-13j to A1-13k.
Architectural Plans	7. We would like to confirm whether the Elevator Pit Depth for PE1, PE2, and PE3 can be increased from 1410 mm to 1600 mm. The current plans indicate a pit depth of 1410 mm. Given that you require a speed of 1.75 m/s, a deeper pit depth is necessary to accommodate this requirement.	Follow as per Plan. For details, refer to: a. Drawing Sheet Nos. A1-15a to A1-15d; and b. Technical Specifications (Part 2), under Division 14 on Conveying Equipment, Section 14 20 00 for the Passenger and Service Elevators. The rated speed is 105 m/min for the passenger elevator, and 60 m/min for service elevator.



Reference	QUERIES	Responses/Clarifications
		The winning Bidder shall nominate three possible suppliers of elevator that can accommodate to the existing elevator pit depth.
Architectural Plans	8. Technical drawings and additional details for Desk 1a-7b.	Refer to: a. Drawing Sheets Nos. FFE 1a to FFE 4g; and b. Technical Specifications (Part 1), under Division 12 – Furnishings, Section 12 00 00 for details and specifications for Desks.
Architectural Plans	9. Granite Stone Nosing FT 1 & FT not visible on the stated plans.	Refer to Drawing Sheets Nos. A1-8a to A1-8l; and A1-10a to A1-10p.

3. On the queries of **RHODIUM 688 BUILDERS, INC.**, the following are the clarifications/answers:

Reference	QUERIES	Responses/Clarifications
Electronics Plans	1. CATV: Is this Analog or IP, if IP what cable to use UTP or Fiber?	It is an Analog. For further details, refer to:
		a. Drawing Sheets No. EC2-2; and
		b. Technical Specifications (Part 3) under Division 27, Section 27 40 00 for the Audio Video System.
Electronics Plans	Digital Signage: Floor layout signage with specification	Refer to Drawing Sheets No. EC2-2a to EC3-2i.
Electronics	3. Master Clock: IP or Analog, and	It is IP. For further details, refer to:
Plans	Floor Layout.	a. Drawing Sheets Nos. EC2-2a to EC3-2i; and
		b. Technical Specifications (Part 3) under Division 27, Section 27 53 13 for the Master Clock System.

4. On the queries of **FINMAT INTERNATIONAL RESOURCES INC.**, the following are the clarifications/answers:

Reference	QUERIES	Responses/Clarifications
General Requirements	Company Profile of the Bidder – Kindly advise what specific content or details must be included in the company profile in order to comply with your procurement standards.	Reference to Section III, under Bid Data Sheet (BDS) Clause 10.1, Item No. 19, page 21 of the OBD, requires that the Bidder's company profile shall indicate the following: a. Names of Principal Officers of composition of the Board of Directors; b. Name(s) of Owner/Stockholders; and c. Line of Works / Services



Reference	QUERIES	Responses/Clarifications
General Requirements	 Certificate of No Negative Slippage – We would like to inquire which office, agency, or authority is mandated to issue this certification. 	Reference to Section III, under BDS Clause 10.1, Item No. 19, page 21 of the OBD, it is the participating Bidder who shall issue the said certification, and must be signed by its duly authorized representative.
General Requirements	3. Certificate of No Slippage Contract – Similarly, we would like clarification on which office or authorized body is responsible for issuing this certificate.	Reference to Section III, under BDS Clause 10.1, Item No. 19, page 21 of the OBD, it is the participating Bidder who shall issue the said certification, and must be signed by its duly authorized representative.
General Requirements	4. Statement of All Ongoing Projects – Kindly advise what supporting documents, if any, are required to be attached to the Statement of All Ongoing Projects for validation purposes.	The required attachments for Form 1: Bidders' Statement of All Ongoing government and private contracts, including contracts awarded but not yet started (if any), which is to be marked as "TCO7" of the Technical Documents, are hereby amended as follows: a. For contract/s awarded but not yet started, Bidders shall attach clear and readable copies of any of the following documents: • Notice of Award; • Notice to Proceed; • Contract/s for the Project/s; or, • Purchase Order. b. For ongoing contract/s, Bidders shall attach clear and readable copies of the following: • Purchase Order/s or Contract/s for the Project/s; and • Certified True Copy of the "Certificate of Work Accomplishment" signed by the Project Owner or his/her Authorized Representatives for
General	5. Prescribed forms for required	all ongoing contracts. Refer to folder named "10 Bidding
Requirements	statements: • Statement of All Ongoing	Forms" in the link provided below for the prescribed forms.
	Government and Private Contracts;	https://drive.google.com/drive/u/ 0/folders/0ABKSwDpPx1gpUk9 PVA
	Statement of Single Largest	Refer to folder named "10 Bidding Forms" in the link provided below for

CPM for the Project based on the

Reference **QUERIES** Responses/Clarifications Completed Contract (SLCC): the prescribed forms. https://drive.google.com/drive/u/ 0/folders/0ABKSwDpPx1qpUk9 **PVA** Qualification of key a. Refer to OBD Section III, under BDS Clause 10.4, pages 21-27, personnel proposed to be for the minimum qualification and assigned to the project; and work experience requirements of the Bidder's key personnel to be assigned to the project; b. The Bidder shall submit, as part of technical components of the bid, the Curriculum Vitae (CV) of all proposed Key Personnel per BDS Clause 10.1, Item No. 9, page 20 of the OBD; and c. Refer to folder named "10 Bidding Forms" in the link provided below for the prescribed format of CV. https://drive.google.com/drive/u/ 0/folders/0ABKSwDpPx1qpUk9 **PVA** a. Refer to OBD Section III, under · List of equipment, owned or BDS Clause 10.5, pages 27-28, and/or leased under for the minimum tools and purchase agreements. equipment units required for the pledge to the proposed project: project b. The Bidder shall submit, as part of technical components of the bid, List of Available Equipment Units, & Equipment Utilization Schedule per BDS Clause 10.1, Item Nos. 12 and 13, page 20 of the OBD; and c. Refer to folder named "10 Bidding Forms" the link provided below for the prescribed Forms for Bidder's List of Available Equipment Units, & Equipment Utilization Schedule. https://drive.google.com/drive/u/ 0/folders/0ABKSwDpPx1gpUk9 **PVA** 6. Preparation of PERT-CPM a. Reference to Section III, BDS General Clause 10.1, Item No. 14, page 20 Requirements of the OBD, Bidders are required to submit a duly signed PERT-

Reference	QUERIES	Responses/Clarifications
		Milestone Activities specified in Section VI. Schedule of Requirements and Specification reflecting the Critical Path of activities.
		b. The Bidder-Contractor may submit their proposed PERT-CPM based on their methodology, field expertise and assessment of the project, as long as the critical path of activities should not exceed 36 calendar months.

Reminder to Bidders:

- 01. Refer to the link below for the e-copies of reference documents included in the Bid Bulletin Nos. 02 and 03, containing (a) DAED / construction plans; (b) As-Built Drawings – existing structure; (c) updated drawings; (d) certificate of accomplishment; (e) monthly progress report submitted; (f) test results; (g) summary report; (h) approved inspection reports; and (i) bidding forms. https://drive.google.com/drive/u/0/folders/0ABKSwDpPx1gpUk9PVA
- 02. The Bid Opening will be on 02 September 2025 (Tue) at 10:00 AM at 1B/F, L.S. Virata Hall, DAP Building, San Miguel Ave., Ortigas Center, Pasig City, Metro Manila. Bids will be opened in the presence of the bidders' authorized representatives who choose to attend the activity.

Bids must be duly received by the BAC Secretariat (BSD) through manual submission at the BAC Secretariat Division Office at the GF, DAP building, San Miguel Avenue, Pasig City on or before 02 September 2025.

BSD Representative will also be at the GF main lobby on 02 September 2025 from 8:00 AM to 10:00 AM to assist the interested bidders in submitting the bids.

03. For further information, please refer to:

RODEL D. CASTILLO

Officer-in-Charge, BAC Secretariat Division

Development Academy of the Philippines

GF, DAP Bldg., San Miguel Avenue, Pasig City 1600

Telephone ¹ (632) 8631-0921 loc. 133 BAC Secretariat email: dapbacsec@dap.edu.ph

Website address https://www.dap.edu.ph

04. Visit the website https://www.dap.edu.ph/invitation-to-bid/ for downloading of the OBD.

For the guidance and information of all concerned.

For the Bids and Awards Committee,

UNE ARVIN C. GUDO

CHAIRPERSON, BIDS & AWARDS COMMITTEE

>>>Nothing Follows<<<

DAPCC SEWAGE TREATMENT PLANT PROCESS FLOW

TREATMENT PROCESS AND PREDICTED TREATMENT EFFICIENCY

The treatment scheme recommended for the STP of principally consists of the following treatment steps:

- 1. Pre-Aeration
- 2. Equalization
- 3. Biological treatment using Upflow Anaerobic Sludge Blanket (UASB)
- 4. Sequencing batch reactor (SBR)
- 5. Disinfection (Chlorine)

PROCESS DESCRIPTION

The selected treatment is a combination of two effective well known processes, in which the organic solids are consumed by the action of anaerobic and aerobic bacteria. The raw sewage from the septic tank is pumped into the pre-aeration tank, where it passes through a manually raked bar screen. Here, large solids and pieces of cloth, plastics and other foreign matters are caught and manually removed into plastic bags for disposal.

From the pre-aeration, wastewater goes to the equalization tank where it homogenizes and serves also as balance tank. The pre-aeration tank is aerated through an air line connected to the air blower with diffusers laid out at the bottom of the tank.

For reduction of excessive fats, oil and grease coming from food tenants, oil is to be skimmed every so often at equalization and pre-aeration with the air supply valve closed. By manual scooping of solidified oil at Oil Pit, FOG entering UASB and SBR is significantly reduced.

In the UASB wastewater from the Equalization Tank is poured near the bottom and equally distributed over its total area. In the lower part of the tank a sludge blanket is maintained through which the wastewater is forced to percolate upwards. This results in sedimentation and absorption of organic waste matter and biological conversion to gas. In the upper part, treated wastewater is separated from the sludge and biogas. Excess sludge is removed once every few years. To keep the sludge blanket in suspension, specific up-flow velocity should be maintained.

From the overflow of the UASB tanks, partially treated wastewater is treated into the next aerobic process by batch widely known as SBR system.

SBR is a variation of conventional activated sludge process usually employing a completely mixed flow pattern.

The operation of the SBR tank is configured to five discrete process sequences, Fill, Mix, Aerate, Settle and Decant. The duration of each phase will depend upon the established schedule of the Program Logic Controller (PLC) of the system giving the operator complete control over the stages of the operation.

After SBR process, treated wastewater is disinfected in the chlorination tank which also serves as the Raw water for Tertiary treatment (Optional).

Treated wastewater can be recycled for toilet flushing & for watering the plants.

Screening, Pre-Aeration Tank and Equalization Tank

The screened sewage goes to the first chamber the Pre-Aeration Tank then overflows to the Equalization tank.

The equalization tank will provide retention and holding of the wastewater prior to succeeding biological treatment. The equalized wastewater is then pumped into SBR, passing through UASB first in a batch mode.

Upflow Anaerobic Sludge Blanket

In the UASB wastewater from the Equalization Tank is poured near the bottom and equally distributed over its total area. In the lower part of the tank a sludge blanket is maintained through which the wastewater is forced to percolate upwards. This results in sedimentation and absorption of organic waste matter and biological conversion to gas. In the upper part, treated wastewater is separated from the sludge and biogas. Excess sludge is removed once every few years. To keep the sludge blanket in suspension, specific up-flow velocity should be maintained.

Sequencing Batch Reactor (SBR)

The SBR process operates on a Fill and Draw principle. Basically, the process follows the steps of Fill, React, Settle and Decant. The actual cycle time for each of the basic steps vary with the effluent requirement.

Sequencing Batch Reactor Systems are a very simple, but sophisticated variation of activated sludge process.

Fill Phase

Under fill phase the reactor is filled with pre-treated wastewater after trickling filtration. During this phase the influent is mixed with the existing liquid and solids in the reactor with air but not always aerated. Fill phase will take about 1 hour.

React Phase

After filling the reactor, the biological and biochemical reactions are normally completed by retention and aeration. The react phase is time measured, which about 2 hours aeration in the reactor of the wastewater and mixed liquor activated sludge.


Settle Phase

Once the aeration is completed, air operation is shut off and the mixed liquor is allowed to settle and separate the clear water zone and settled mixed liquor. The settle or decant phase will take place for about one hour.

Decant Phase


Under this phase, the clear water is discharge or withdrawn by floating decant pumps for final discharge. The decant period will take place for about one hour or more.


Figure 2 shows the various SBR phases and or operating diagram.

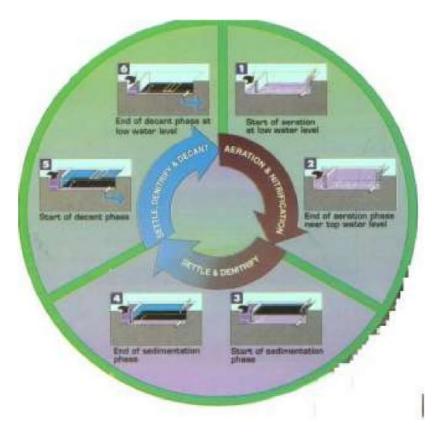



CONTROL PANEL

The control panel was designed and built using quality components from SIEMENS. Each branch has circuit breaker to protect the motors of the system. Panel lights were also installed to indicate which equipments were running. It also incorporates over/under voltage sensor to shut down the down the operation should the line voltage drops or exceeds the pre-set value. Liquid level controls were also provided to protect the pumps from running dry. Panel switches were mounted at the front. This switches control the operation of the equipments. During automatic mode of operation all parameters such as water level and time of aeration, decant time, transfer time, and chlorination were done by the programmable logic control to execute the necessary sequence, however, during manual mode of operation the operator has to manual switch on or off the corresponding equipment required for operation. The programmable logic control has a small display indicating the phase of operation.

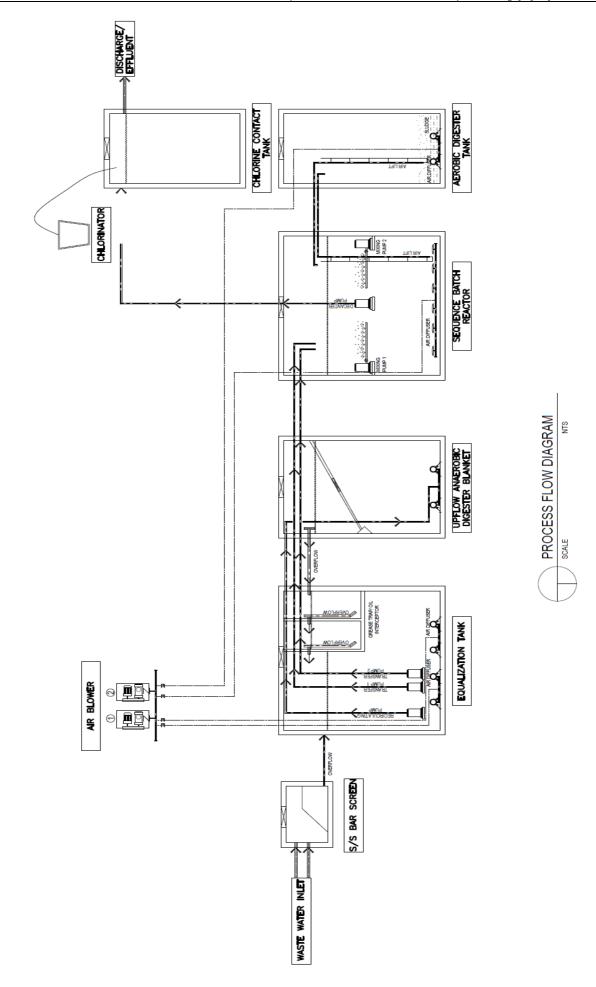

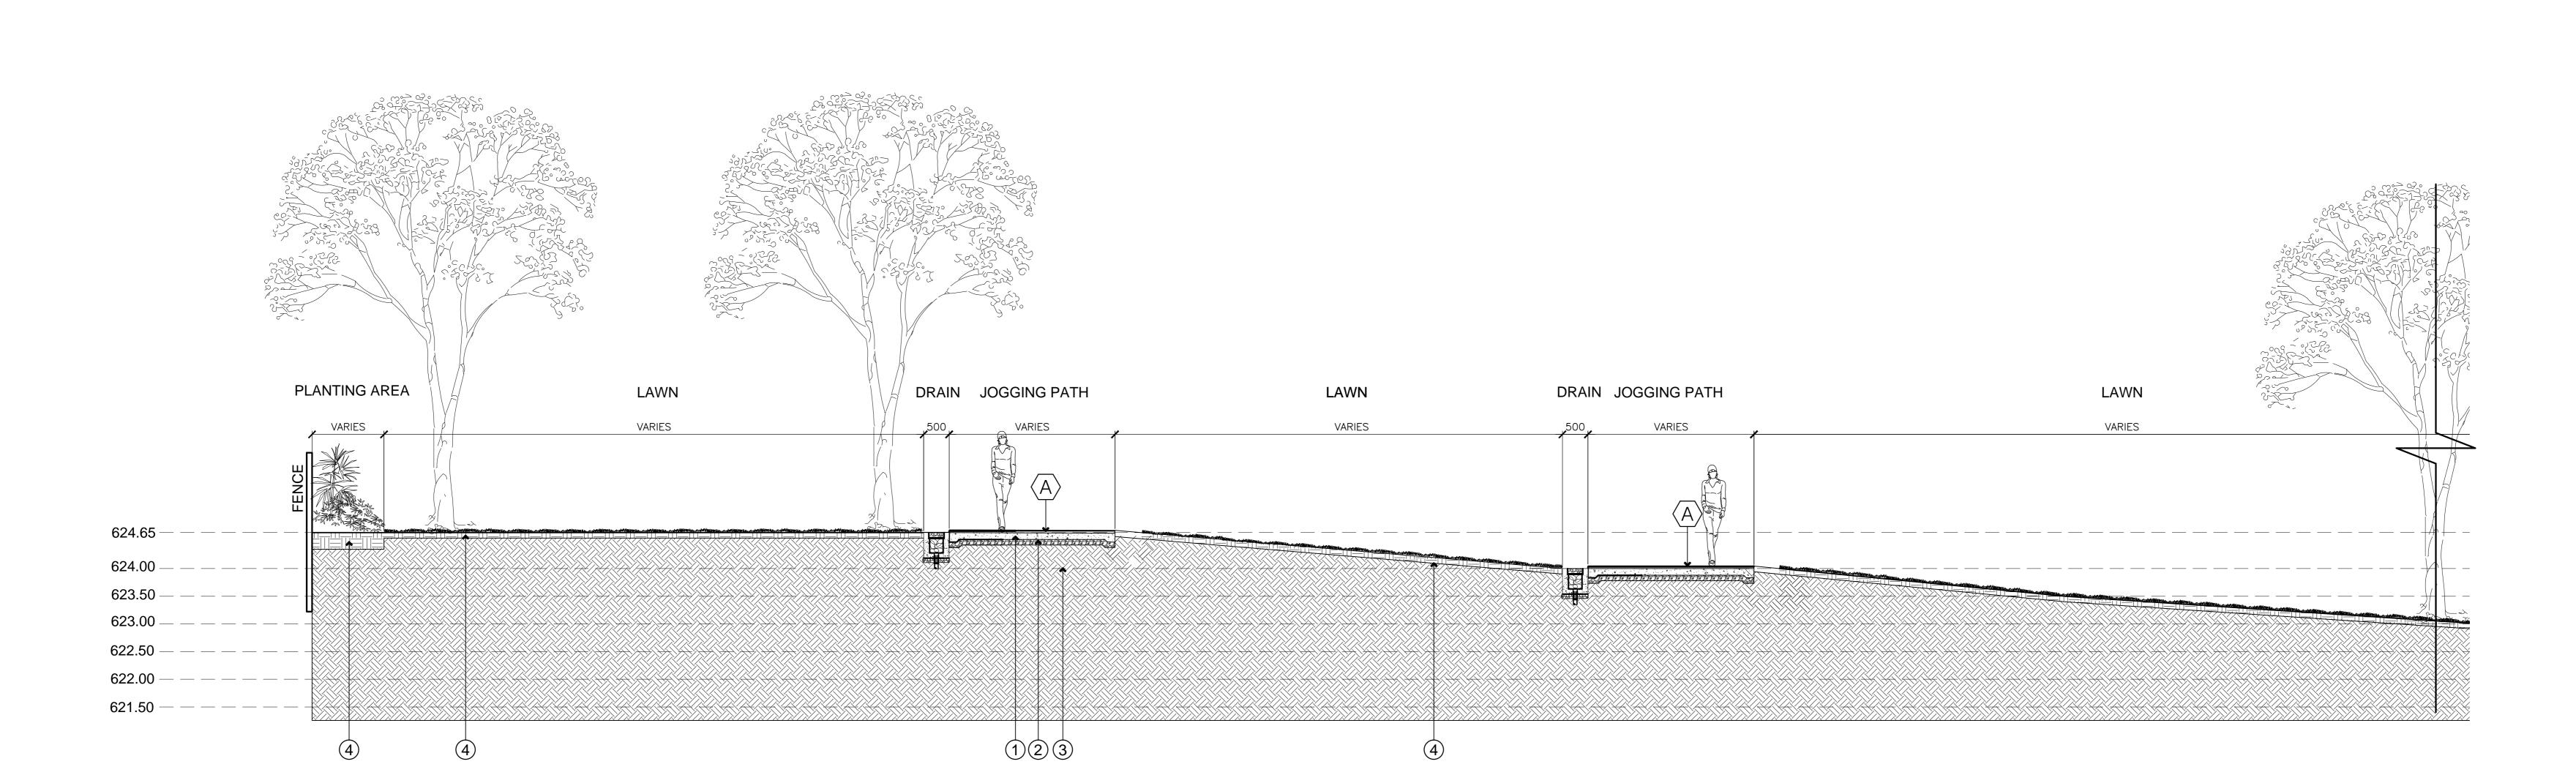

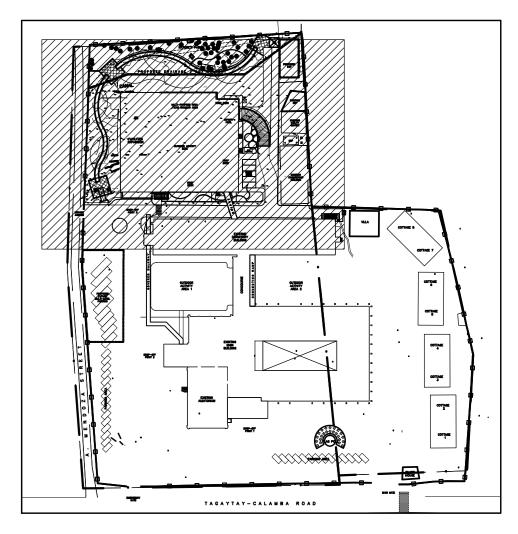

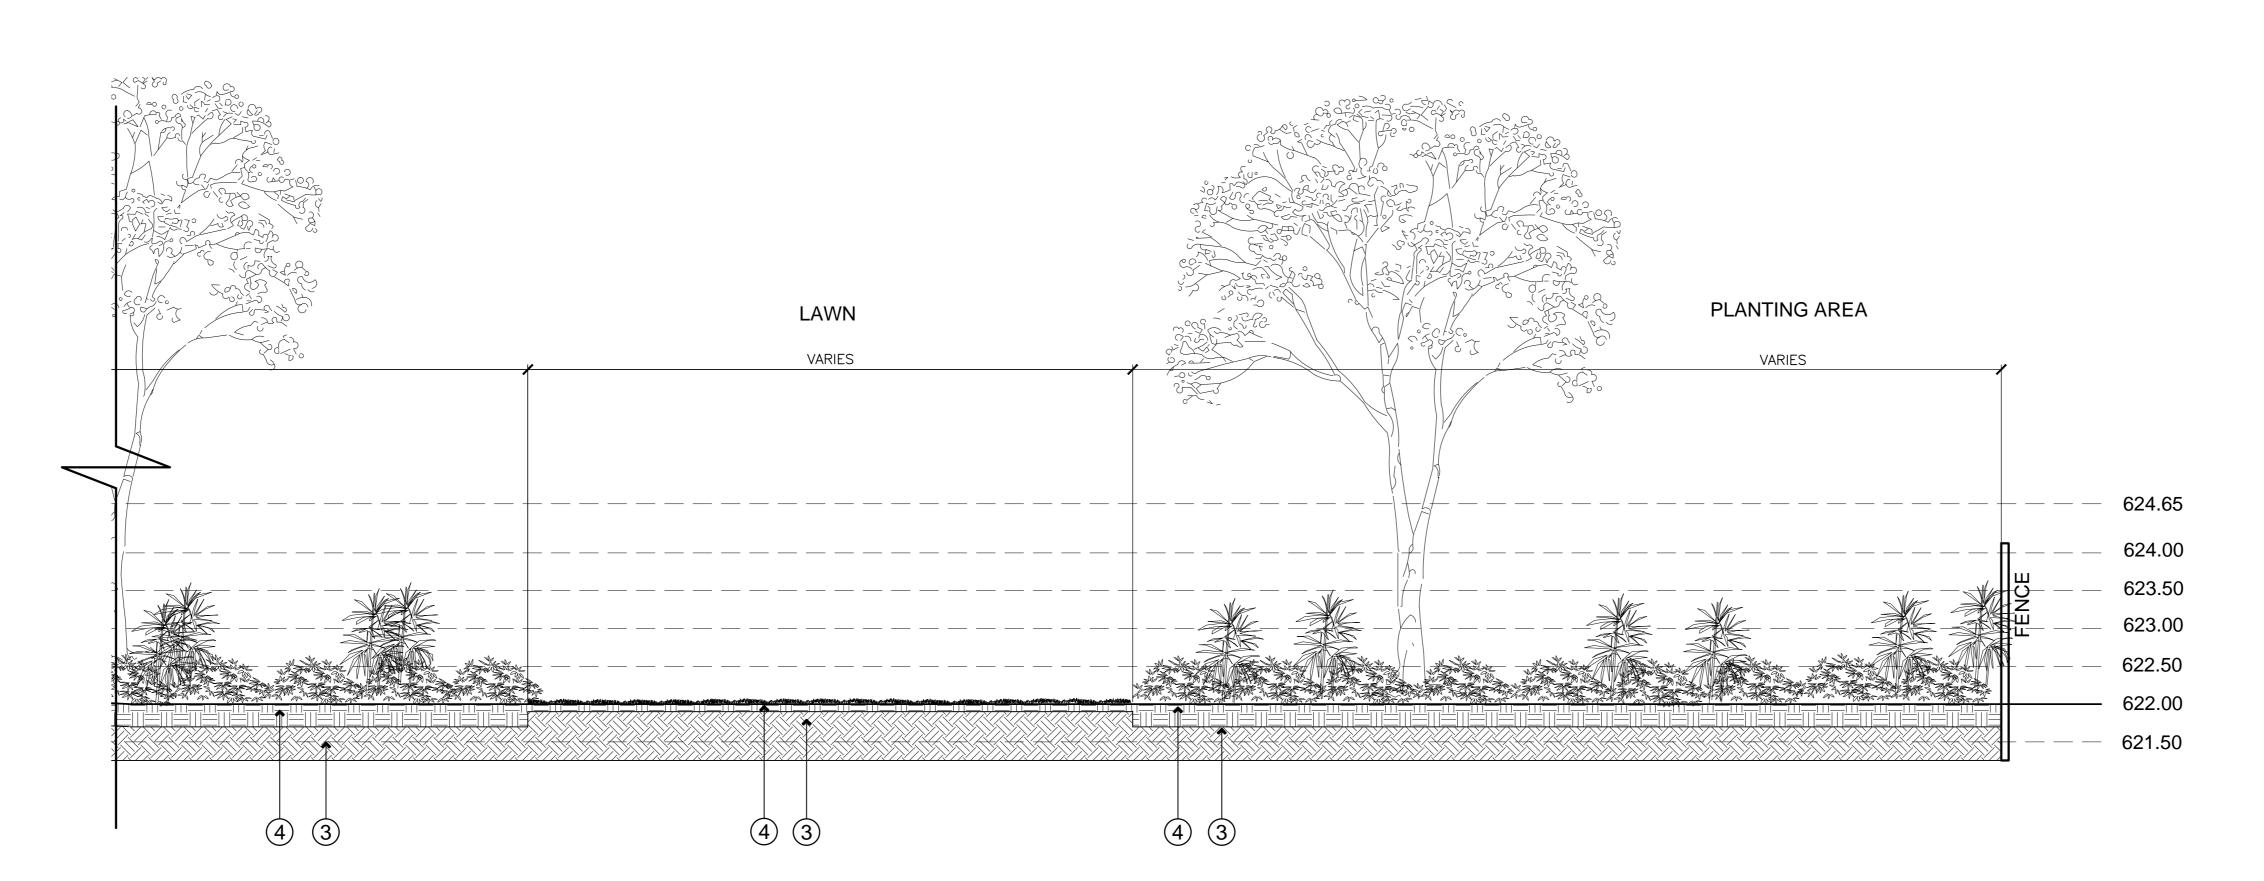

SECTION ELEVATION 1:75MTS.

LEGEND:

- $\frac{1}{2}$ 300 MM EACH WAY (2) 100 MM THICK GRAVEL BASE
- 3 COMPACTED SUB-GRADE

-ALL DIMENSIONS SHALL BE VERIFIED ON ACTUAL LOCATION. -ANY EQUIVALENT MATERIAL SHALL BE APPROVED BY LANDSCAPE ARCHITECT. -ALL STRUCTURES VERIFY TO STRUCTURAL ENGINEER. -GARDEN SOIL MIN. DEPTH SHALL BE: 100MM (LAWN AREA) 300MM (SHRUBS) 1.2 CUBIC METER (TREES AND PALMS)


THE REVIEW AND APPROVAL OF THESE PLANS AND DOCUMENTS
BY THE DEPARTMENT OF PUBLIC WORKS AND HIGHWAYS DOES
NOT RELIEVE THE CONSULTANT OF ACCOUNTABILITY AND THE
RESPONSIBILITY FOR THE SAFETY OF THE STRUCTURE(S) PROJECT NO.: SHEET NO.: REVISION:


LANDSCAPE ARCHITECT: PROJECT TITLE: CONCURRED: REVIEWED AS TO DESIGNED CONCEPT: RECOMMENDING APPROVAL: APPROVED: OWNER: SHEET CONTENTS: CONSULTANT: SECTION ELEVATION Construction of a Fourteen-Storey Reinforced Concrete Building comprising Four-Storey Multi-use ARCE • BAILON • ARCE REPUBLIC OF THE PHILIPPINES 16-06 LGF-SE-01 DEVELOPMENT ACADEMY Development and various Site Improvements at the DAP Conference Center in Tagaytay City for the purposes of (SEE COVER SHEET FOR SIGNATURE) (SEE COVER SHEET FOR SIGNATURE) (SEE COVER SHEET FOR SIGNATURE) ARCHITECTS •ENGINEERS •CONSULTANTS

14 SCOUT BORROMEO STREET, SOUTH TRIANGLE, QUEZON CITY.


TRUNKLINE.: 8355 2323 FAX NO.: 8355 1080

www.arcebailonarce.com OF THE PHILIPPINES EFREN A. AURELIO, pala AND HIGHWAYS "Strengthening the Capacity of the Development Academy of the Philippines to Provide both General & Highly JOSEPHINE P. ISTURIS CHIEF, BUILDINGS DIVISION, BOD, DPWH EMIL K. SADAIN, CESO I UNDERSECRETARY FOR UPMO OPERATIONS & TECHNICAL SERVICES, DPWH ATTY. ENGELBERT C. CARONAN, JR., MNSA PRESIDENT AND CHIEF EXECUTIVE OFFICER, DAP ENGR. ARISTARCO M. DOROY BONIFACIO DRIVE, PORT AREA, MANILA Specialized Training Courses for the Government Officials" OFFICER-IN-CHARGE, BOD, DPWH 0015 PTR NO.: 9264968 CAD ENCODER: 6844 PTR NO.: CHECKED BY: FGM REPUBLIC ACT 9266: This drawing, as an instrument of service, is the property of ARCE-BAILON-ARCE ARCHITECTS, registered Architecture, Model and Designs are creative works and considered as part of the intellectual property of the author.

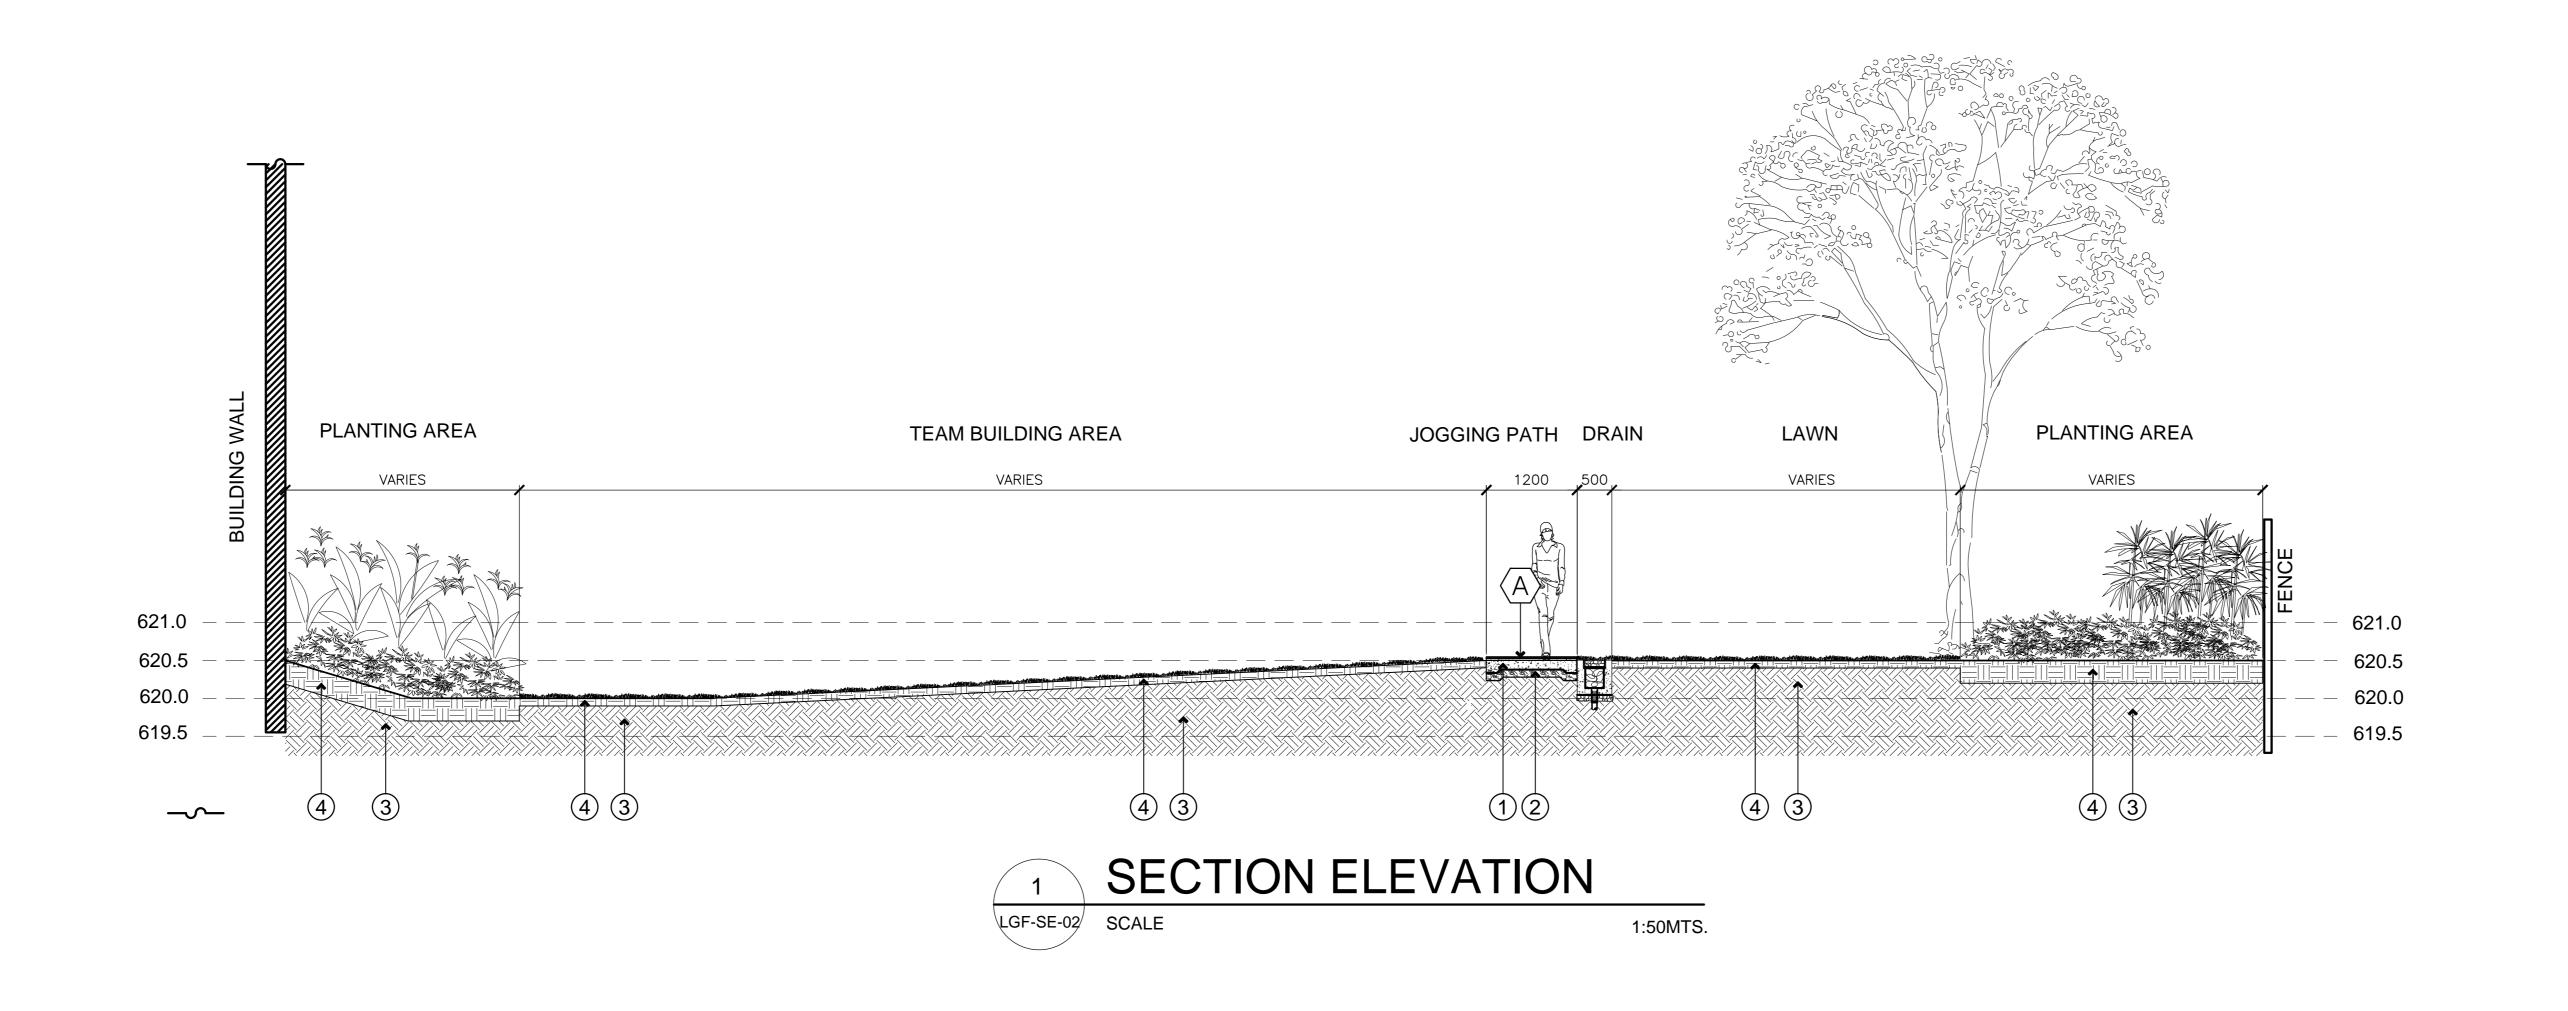

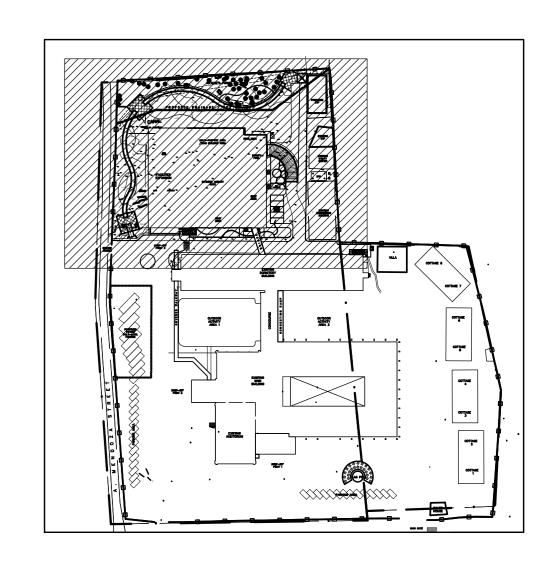

KEY PLAN SCALE 1:2000MTS.

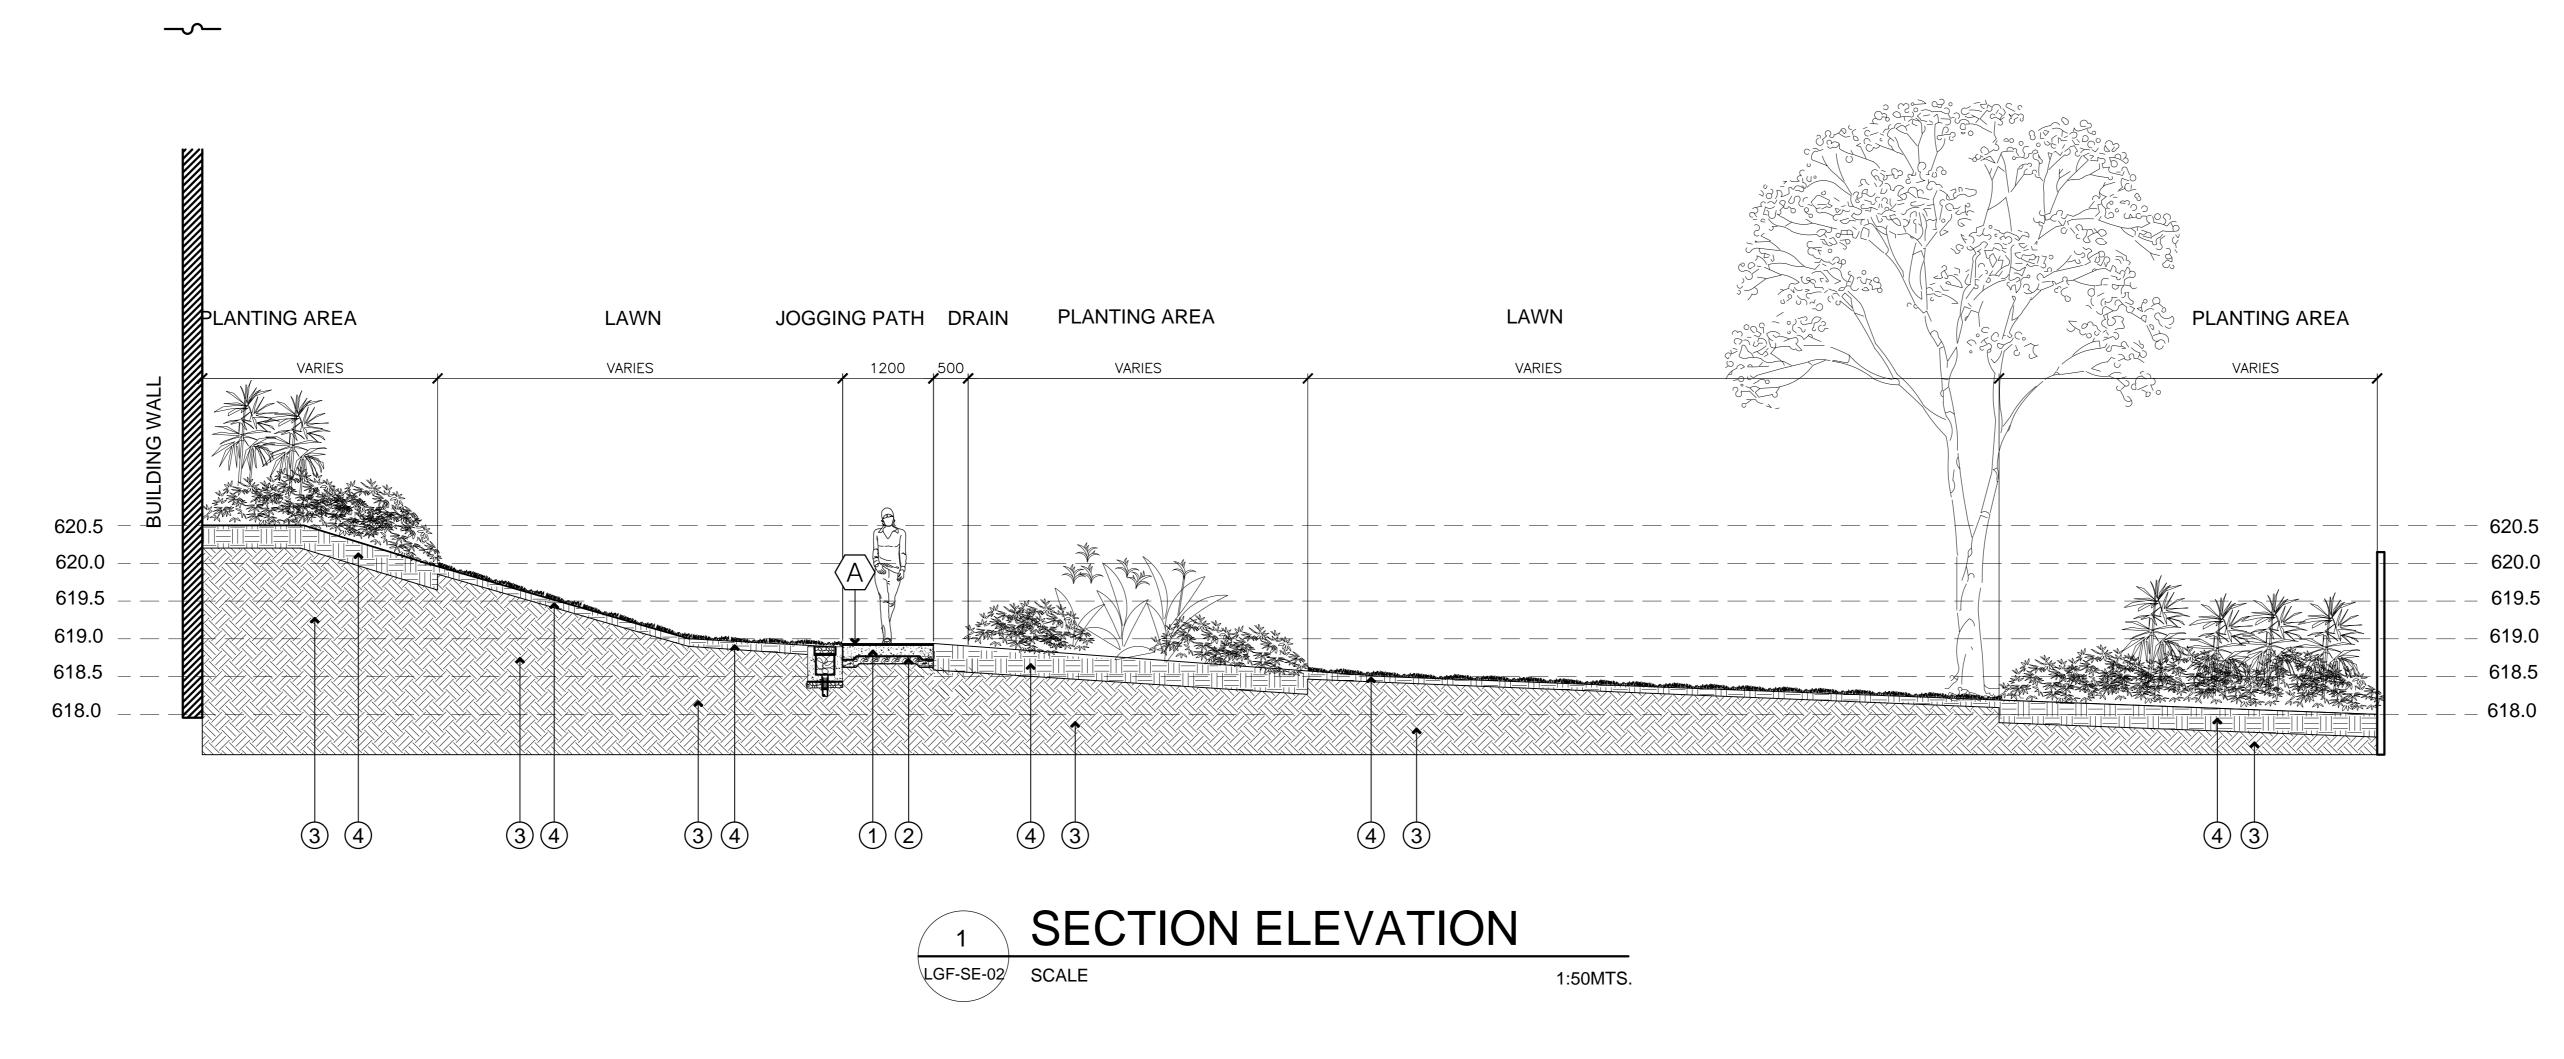

LEGEND:

A TRU-FLEX WITH FOUR (4) COATED CUSHION

1 REINFORCED CONCRETE STRUCTURE 100 THK. R.C. SLAB WITH 10MMØ REINFORCING STEEL BARS AT 300 MM EACH WAY


2 100 MM THICK GRAVEL BASE

3 COMPACTED SUB-GRADE


GARDEN SOIL
TO LA'S APPROVAL


-ALL DIMENSIONS SHALL BE VERIFIED ON ACTUAL LOCATION. -ANY EQUIVALENT MATERIAL SHALL BE APPROVED BY LANDSCAPE ARCHITECT. -ALL STRUCTURES VERIFY TO STRUCTURAL ENGINEER.

	<u> </u>											BY THE DEPARTMENT NOT RELIEVE THE CO	PROVAL OF THESE PLANS . T OF PUBLIC WORKS AND ONSULTANT OF ACCOUNT FOR THE SAFETY OF THE S	HIGHWAYS DOE ABILITY AND TH
CONSULTANT:		PRINCIPAL ARCHITECT:	LANDSCAPE ARCHITECT:	PROJECT TITLE:		REVIEWED AS TO DESIGNED CONCEPT:	RECOMMENDING APPROVAL:	APPROVED:	OWNER:	CONCURRED:	SHEET CONTENTS:	REVISION:	PROJECT NC	.: SHEET NO.:
ARCE • BAILON • A ARCHITECTS • ENGINEERS • CONSI 14 SCOUT BORROMEO STREET, SOUTH TRIANGLE, TRUNKLINE: 8355 2323 FAX NO.: 8355 14 www.arcebailonarce.com	SULTANTS E, QUEZON CITY.	MARIANO S. ARCE, JR., fuap REG. NO.: 6844 PTR NO.: 9379551 TIN: 129-343-871 DATE: 0.007/20 QC	REG. NO.: 0015 PTR NO.: 9264968 TIN: 200-751-501 DATE: 01/08/20 QC	Construction of a Fourteen-Storey Reinforced Concrete Building comprising Four-Storey Multi-use Podium, Ten-Storey Accommodation Tower with Roof Deck and Basement Parking & Utilities including Site Development and various Site Improvements at the DAP Conference Center in Tagaytay City for the purposes of "Strengthening the Capacity of the Development Academy of the Philippines to Provide both General & Highly Specialized Training Courses for the Government Officials"	REPUBLIC OF THE PHILIPPINES DEPARTMENT OF PUBLIC WORKS AND HIGHWAYS BONIFACIO DRIVE, PORT AREA, MANILA	(SEE COVER SHEET FOR SIGNATURE) JOSEPHINE P. ISTURIS CHIEF, BUILDINGS DIVISION, BOD, DPWH	(SEE COVER SHEET FOR SIGNATURE) ENGR. ARISTARCO M. DOROY OFFICER-IN-CHARGE, BOD, DPWH	(SEE COVER SHEET FOR SIGNATURE) EMIL K. SADAIN, CESO I UNDERSECRETARY FOR UPMO OPERATIONS & TECHNICAL SERVICES, DPWH	DEVELOPMENT ACADEM OF THE PHILIPPINES	ATTY. ENGELBERT C. CARONAN, JR., MNSA PRESIDENT AND CHIEF EXECUTIVE OFFICER, DAP	SECTION ELEVATION	DESIGNED BY: CAD EN	16-06 NCODER: CHECKED BY: FGM MSAJ	LGF-SE-(DATE: JUNE 2017

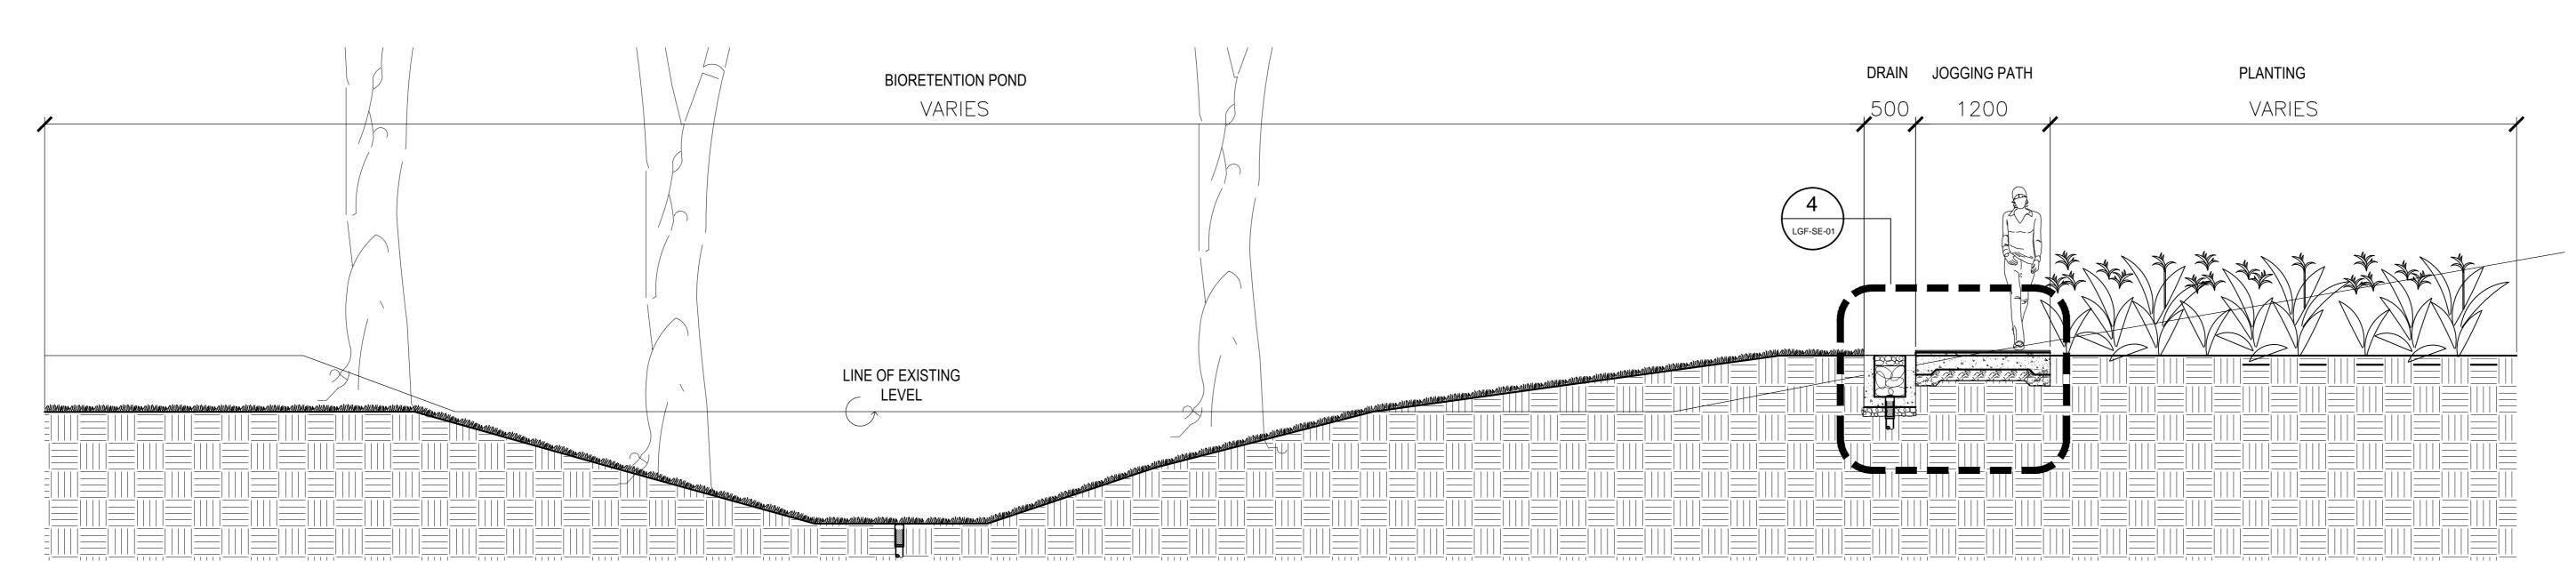


SECTION-ELEVATION: BIORETENTION POND LGF-SE-03 SCALE 1:40MTS.

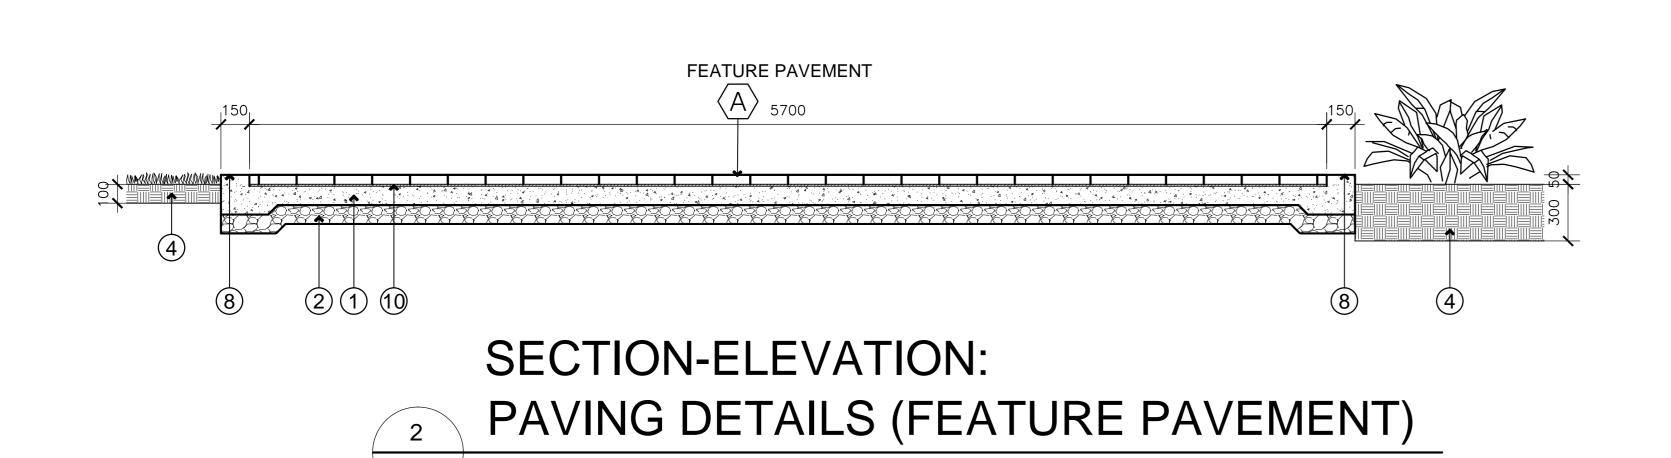

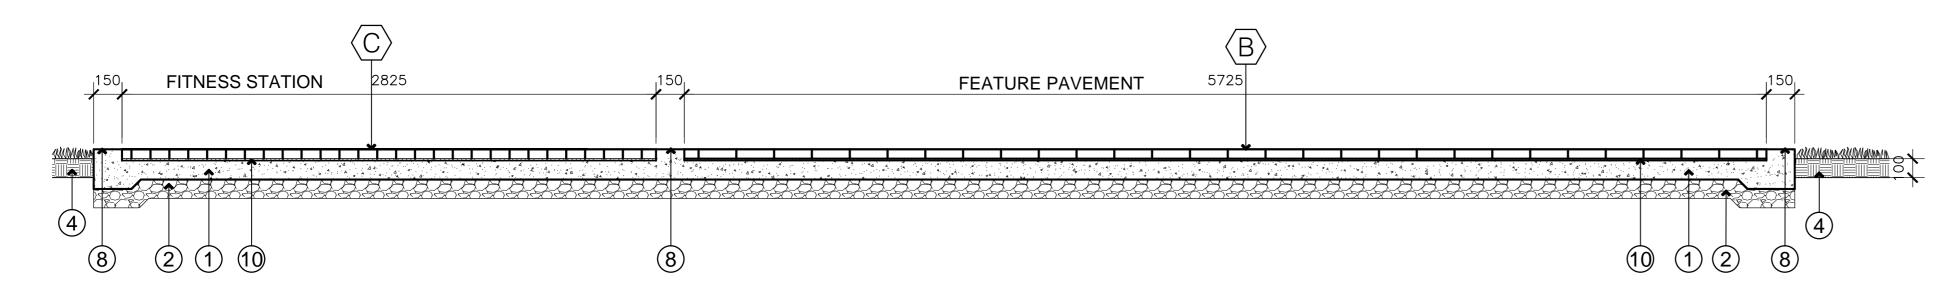

REPUBLIC ACT 9266: This drawing, as an instrument of service, is the property of ARCE-BAILON-ARCE ARCHITECTS, registered Architectual Property of the author.



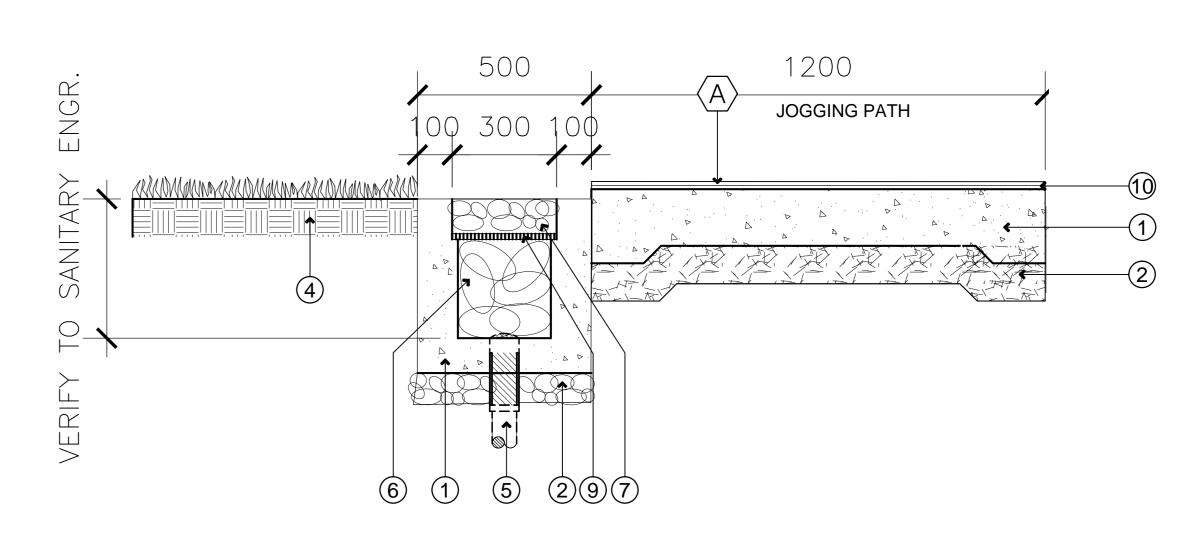



LEGEND

- A TRU-FLEX WITH FOUR (4) COATED CUSHION
- 50 X 100 X 200MM

 PAVER BLOCKS SET IN CONCRETE
- COLOR:TERRACOTA, GRAY
 50 X 100 X 200MM
- PAVER BLOCKS SET IN CONCRETE STRETCHER BOND PATTERN COLOR:GRAY
- REINFORCED CONCRETE STRUCTURE 100 THK. R.C. SLAB V
- (2) 100 MM THK. GRAVEL BED
- GARDEN SOIL, TO LA'S APPROVAL
- DRAIN PIPE
 TO ENGINEER'S DETAILS
- 6 LOOSE STONES
- 7 38 MM DIA. KUDOS STONES
- 8 CONCRETE BAND9 STEEL GRATE
- 10 C/S MORTAR SCREEDING LAYER


NOTE:


-ALL DIMENSIONS SHALL BE VERIFIED ON ACTUAL LOCATION.


-ANY EQUIVALENT MATERIAL SHALL BE APPROVED BY LANDSCAPE ARCHITECT.


-ALL STRUCTURES VERIFY TO STRUCTURAL ENGINEER.


								THE REVIEW AND APPROVAL OF T BY THE DEPARTMENT OF PUBLIC ON NOT RELIEVE THE CONSULTANT OF RESPONSIBILITY FOR THE SAF	WORKS AND HIG OF ACCOUNTABL	HWAYS DOES
CONSULTANT: PRINCIPAL ARCHITECT: LANDSCAPE ARCHITECT: PROJECT TITLE:		REVIEWED AS TO DESIGNED CONCEPT: RE	ECOMMENDING APPROVAL:	APPROVED:	OWNER:	CONCURRED:	SHEET CONTENTS:	REVISION:	PROJECT NO.:	SHEET NO.:
ARCE BAILON ARCE ARCHITECTS ENGINEERS CONSULTANTS 14 SCOUT BORROMEO STREET, SOUTH TRIANGLE, QUEZON CITY. TRUNKLINE: 8355 2323 FAX NO.: 8355 1080 MARIANO S. ARCE, JR., fuap MARIANO S. ARCE, JR., fuap MARIANO S. ARCE, JR., fuap	A-Storey Reinforced Concrete Building comprising Four-Storey Multi-use dation Tower with Roof Deck and Basement Parking & Utilities including Site provements at the DAP Conference Center in Tagaytay City for the purposes of the Development Academy of the Philippines to Provide both General & Highly alized Training Courses for the Government Officials" REPUBLIC OF THE PHILIPPINES DEPARTMENT OF PUBLIC WORKS AND HIGHWAYS BONIFACIO DRIVE, PORT AREA, MANILA	(SEE COVER SHEET FOR SIGNATURE) JOSEPHINE P. ISTURIS CHIEF, BUILDINGS DIVISION, BOD, DPWH	(SEE COVER SHEET FOR SIGNATURE) ENGR. ARISTARCO M. DOROY OFFICER-IN-CHARGE, BOD, DPWH	(SEE COVER SHEET FOR SIGNATURE) EMIL K. SADAIN, CESO I UNDERSECRETARY	DEVELOPMENT ACADEMY OF THE PHILIPPINES	ATTY. ENGELBERT C. CARONAN, JR., MNSA PRESIDENT AND CHIEF EXECUTIVE OFFICER, DAP	SECTION ELEVATION		16-06 เ	_GF-SE-03
REG. NO.: 6844 PTR NO.: 9379551 REG. NO.: 0015 PTR NO.: 9264968 TIN: 129-343-871 DATE: 0\(\text{V07/20 QC} \) TIN: 200-751-501 DATE: 01/08/20 QC	and I mining courses for the core mineral officials			FOR UPMO OPERATIONS & TECHNICAL SERVICES, DPWH				DESIGNED BY: CAD ENCODER: C	CHECKED BY:	DATE:

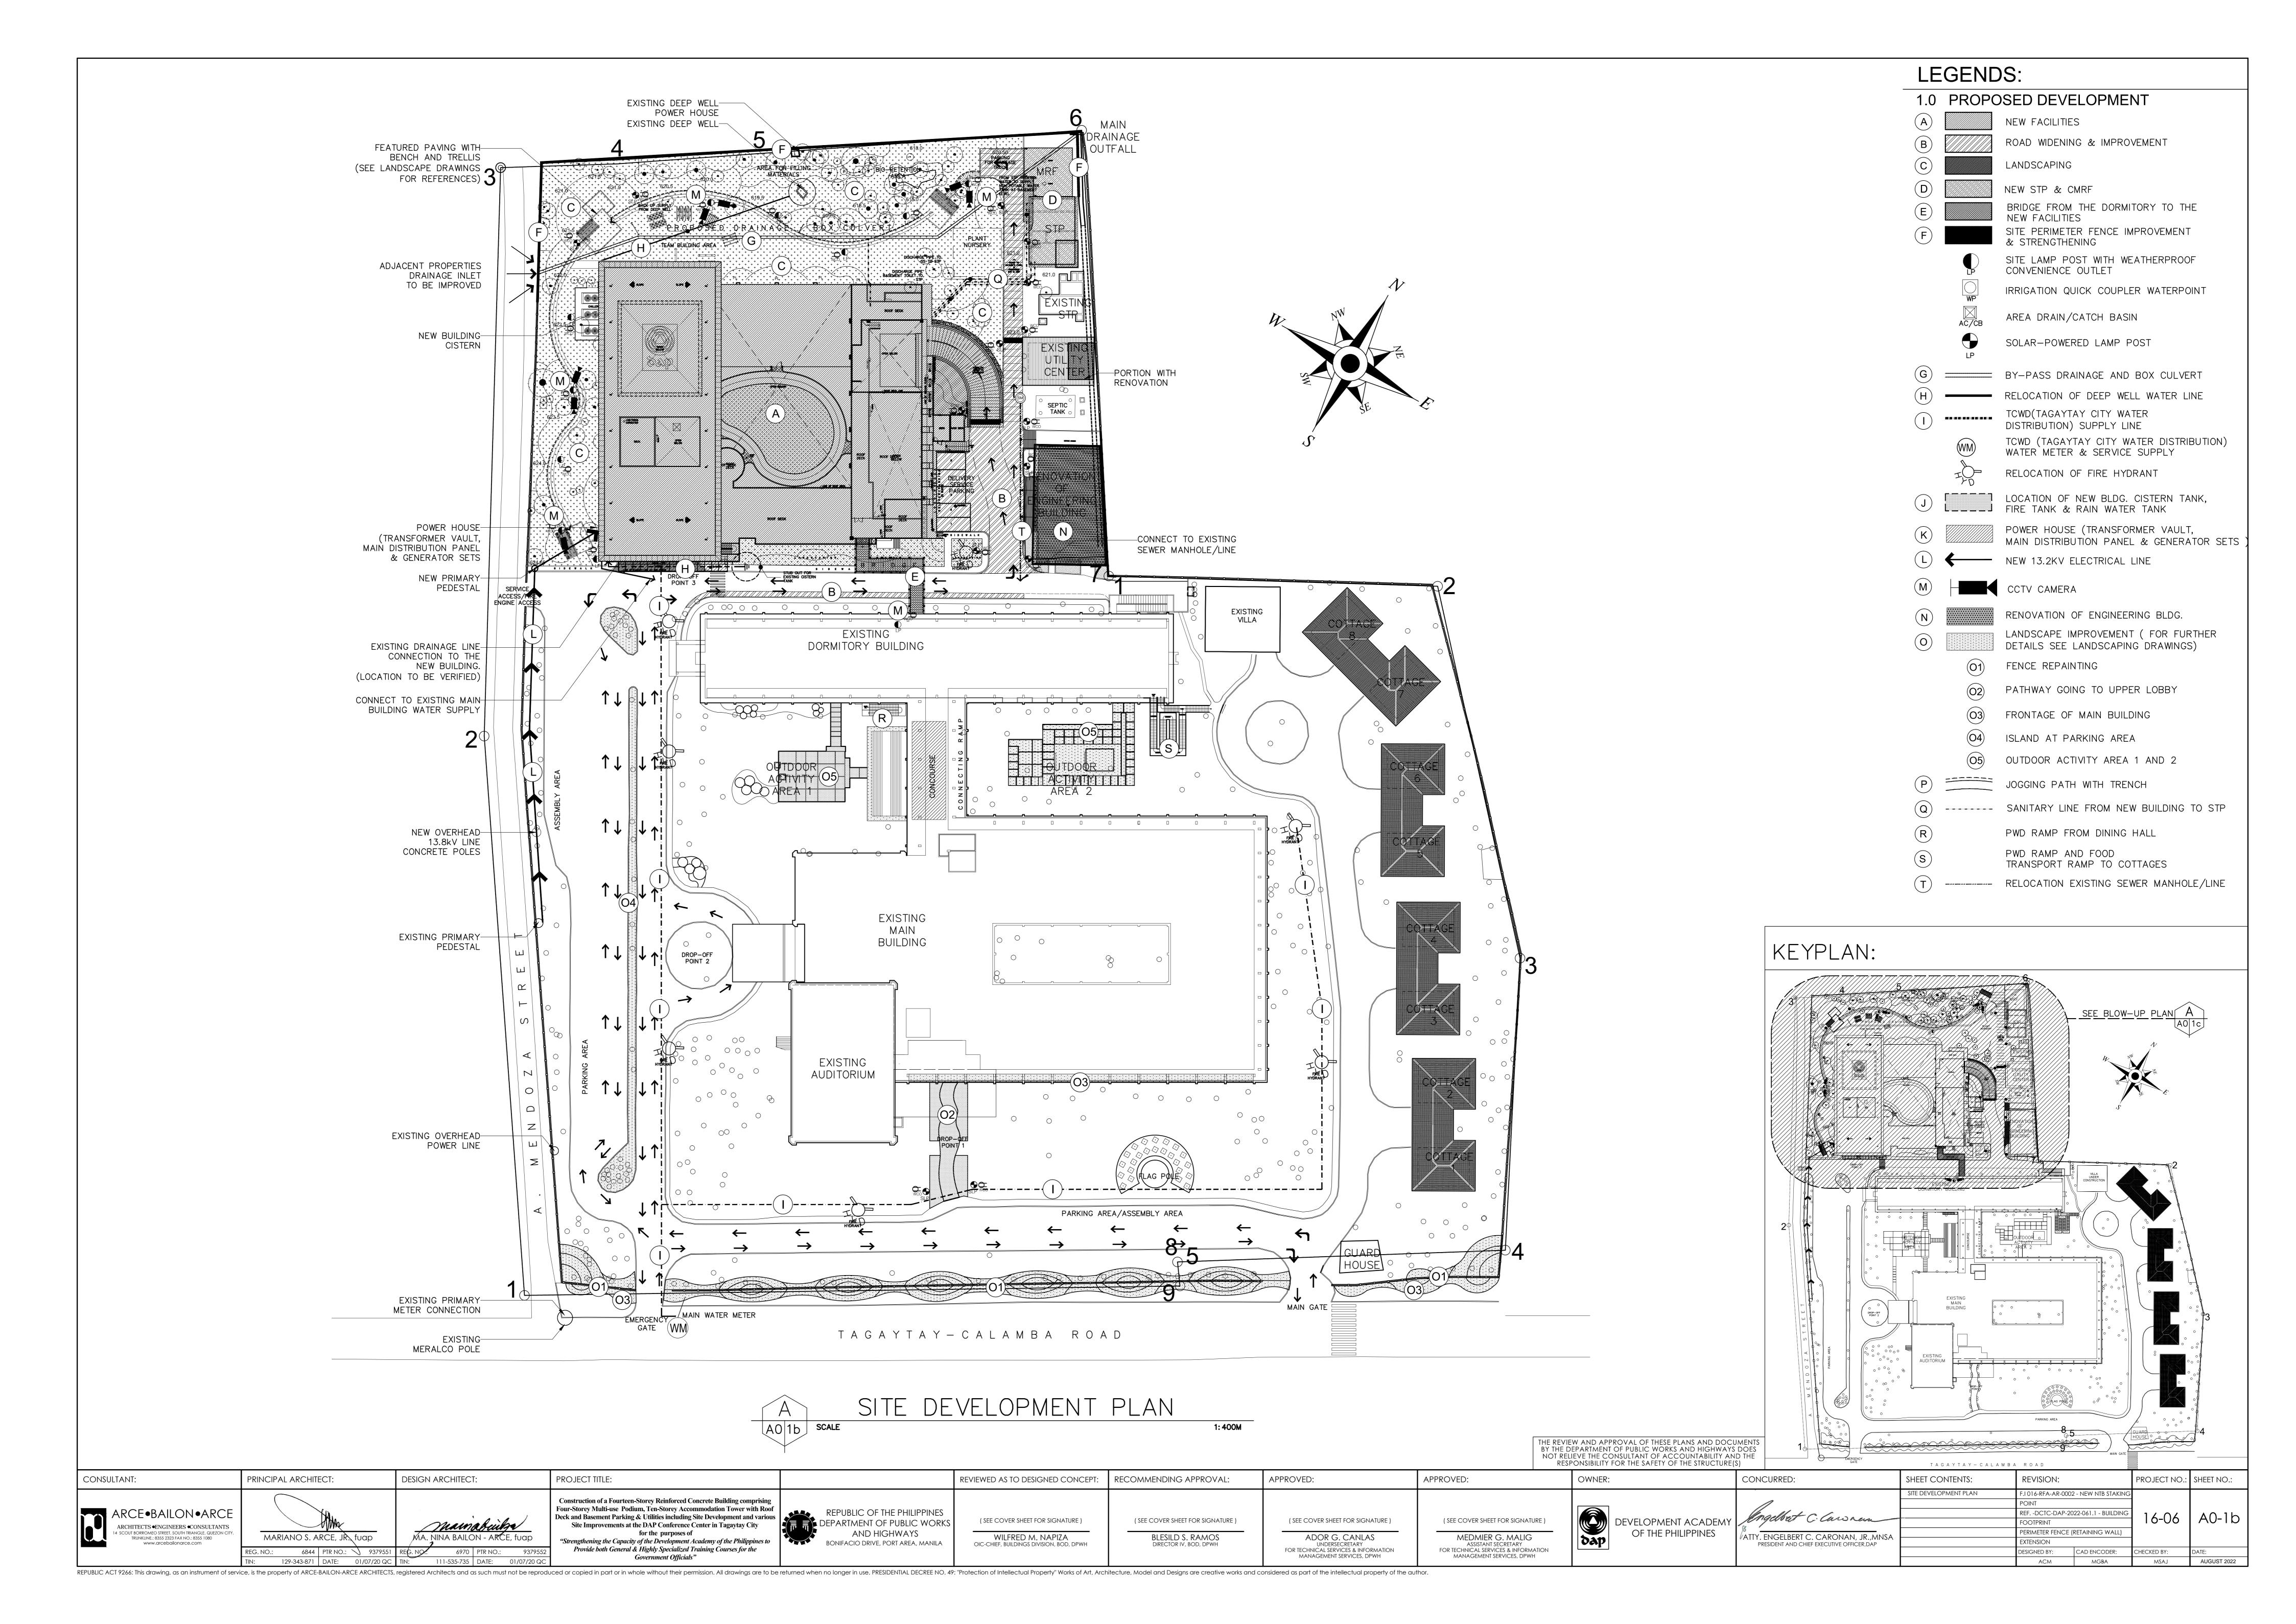


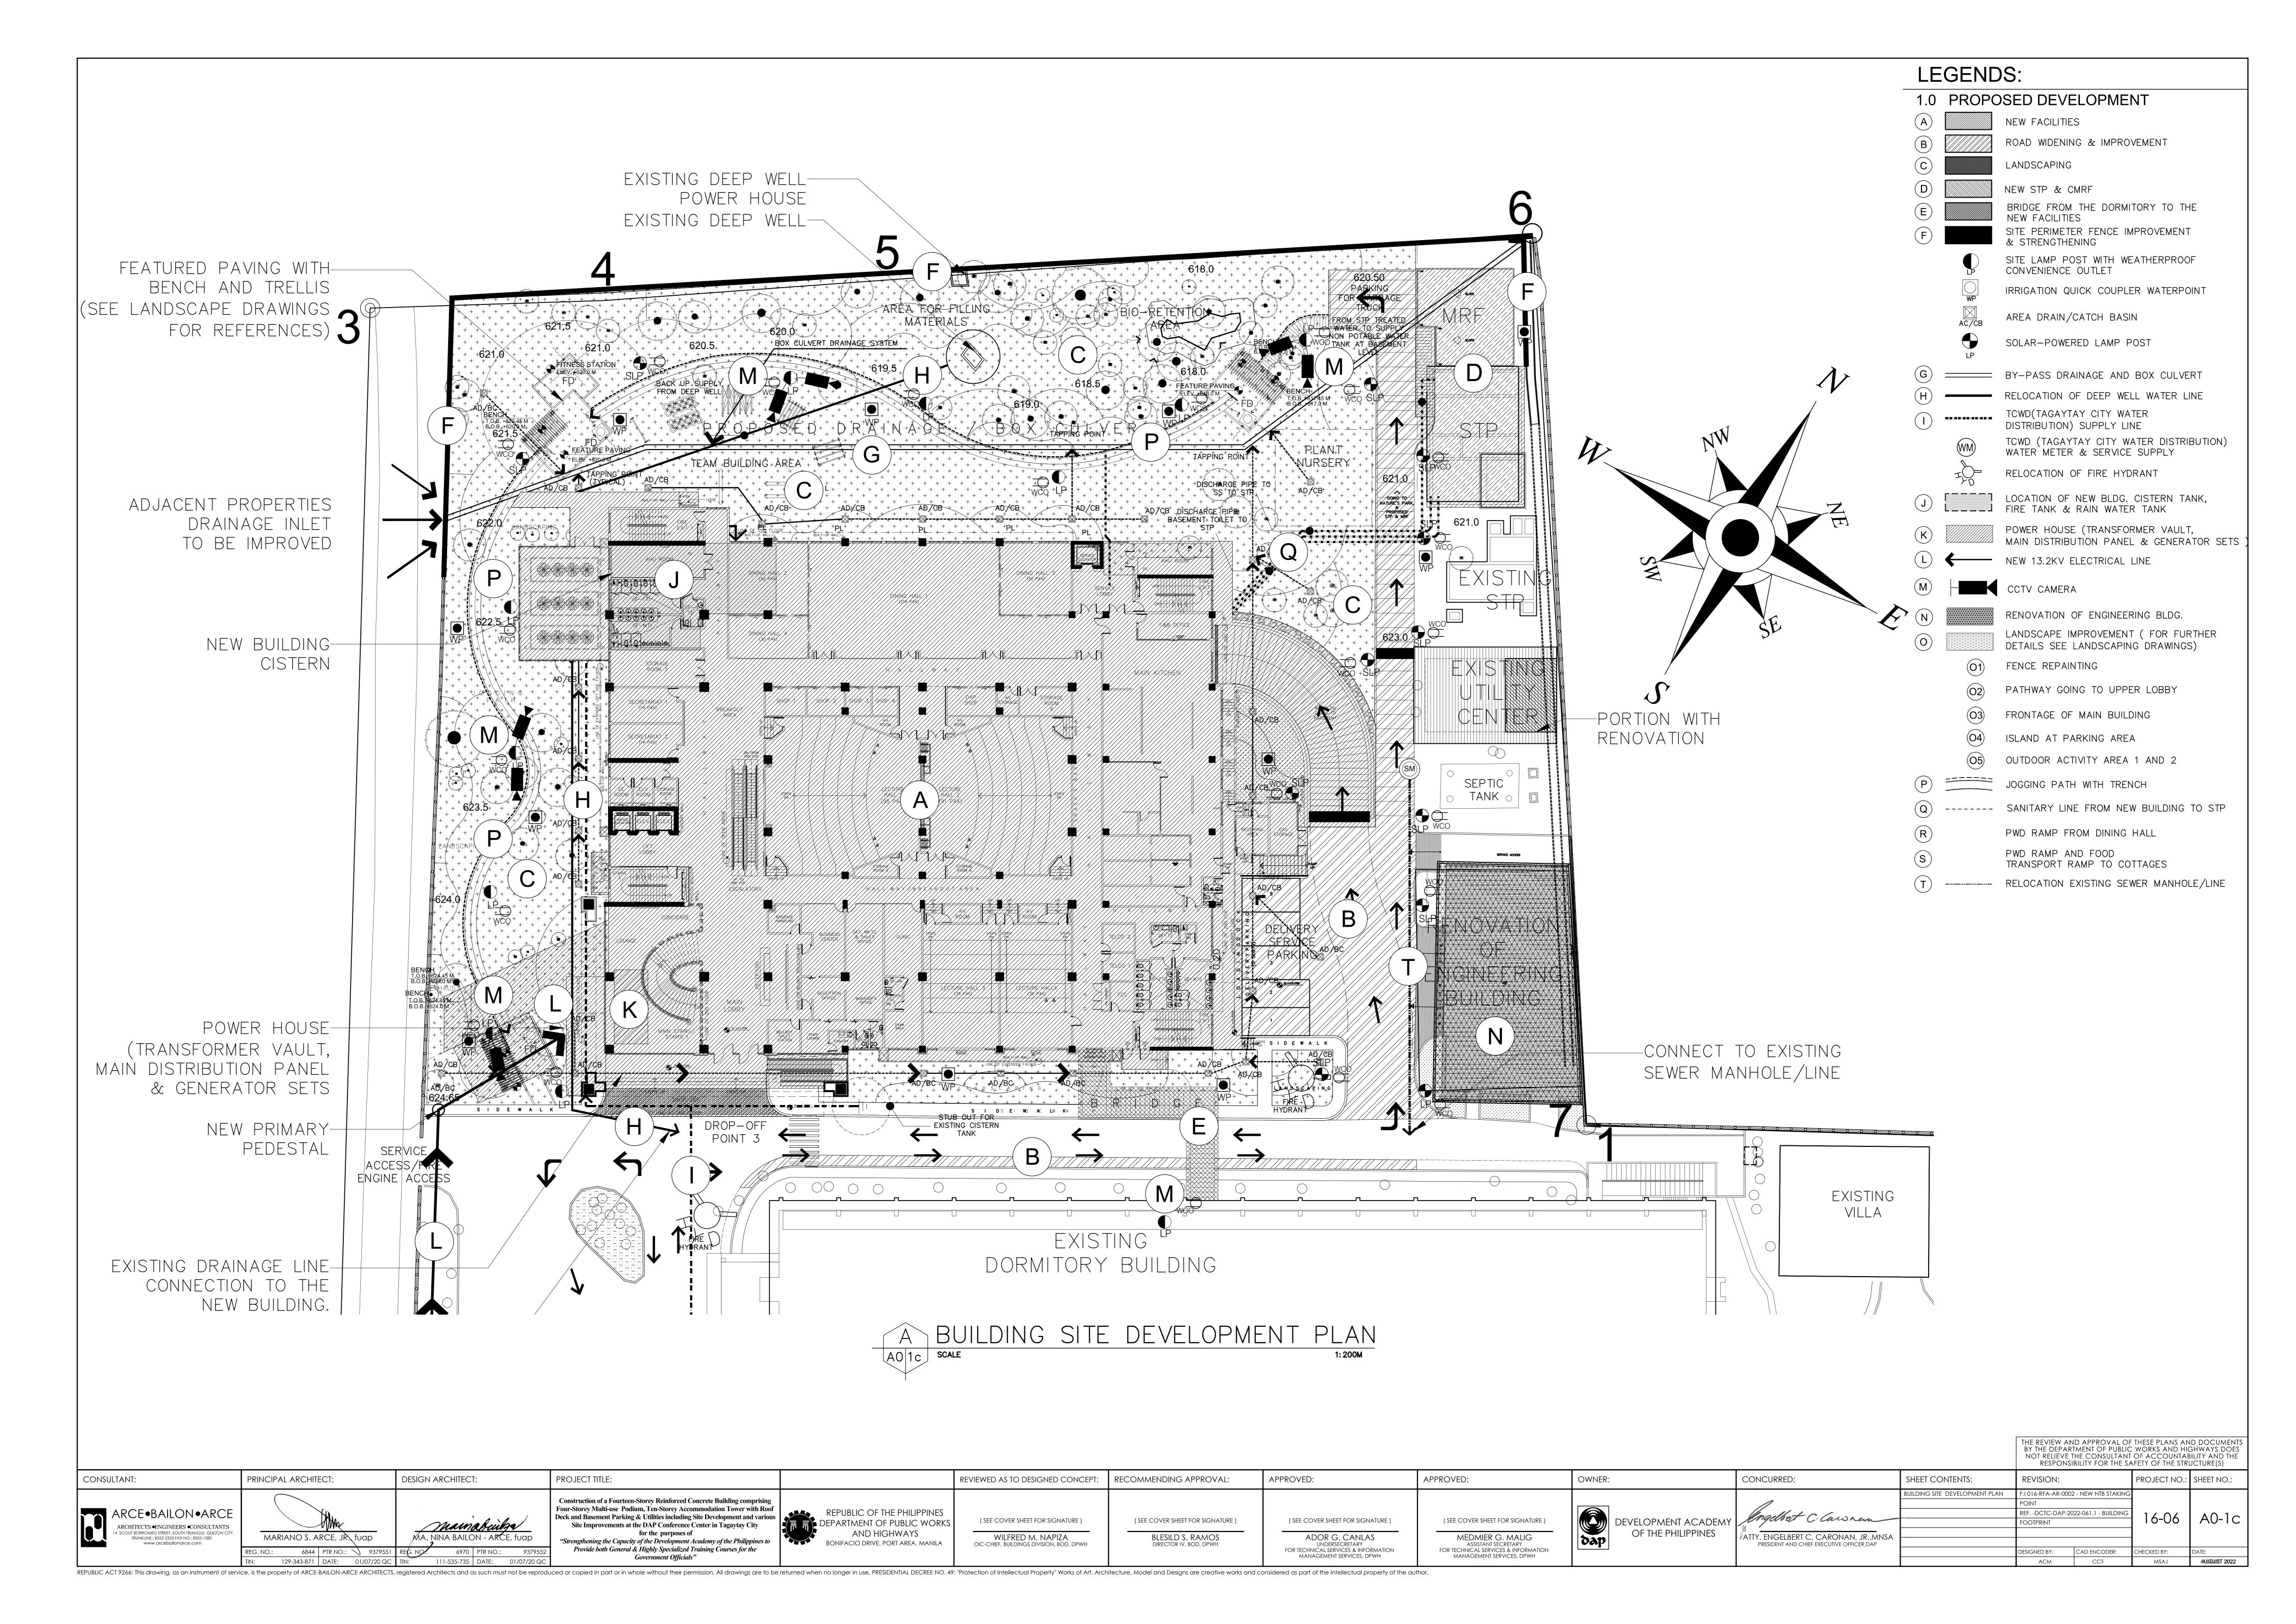


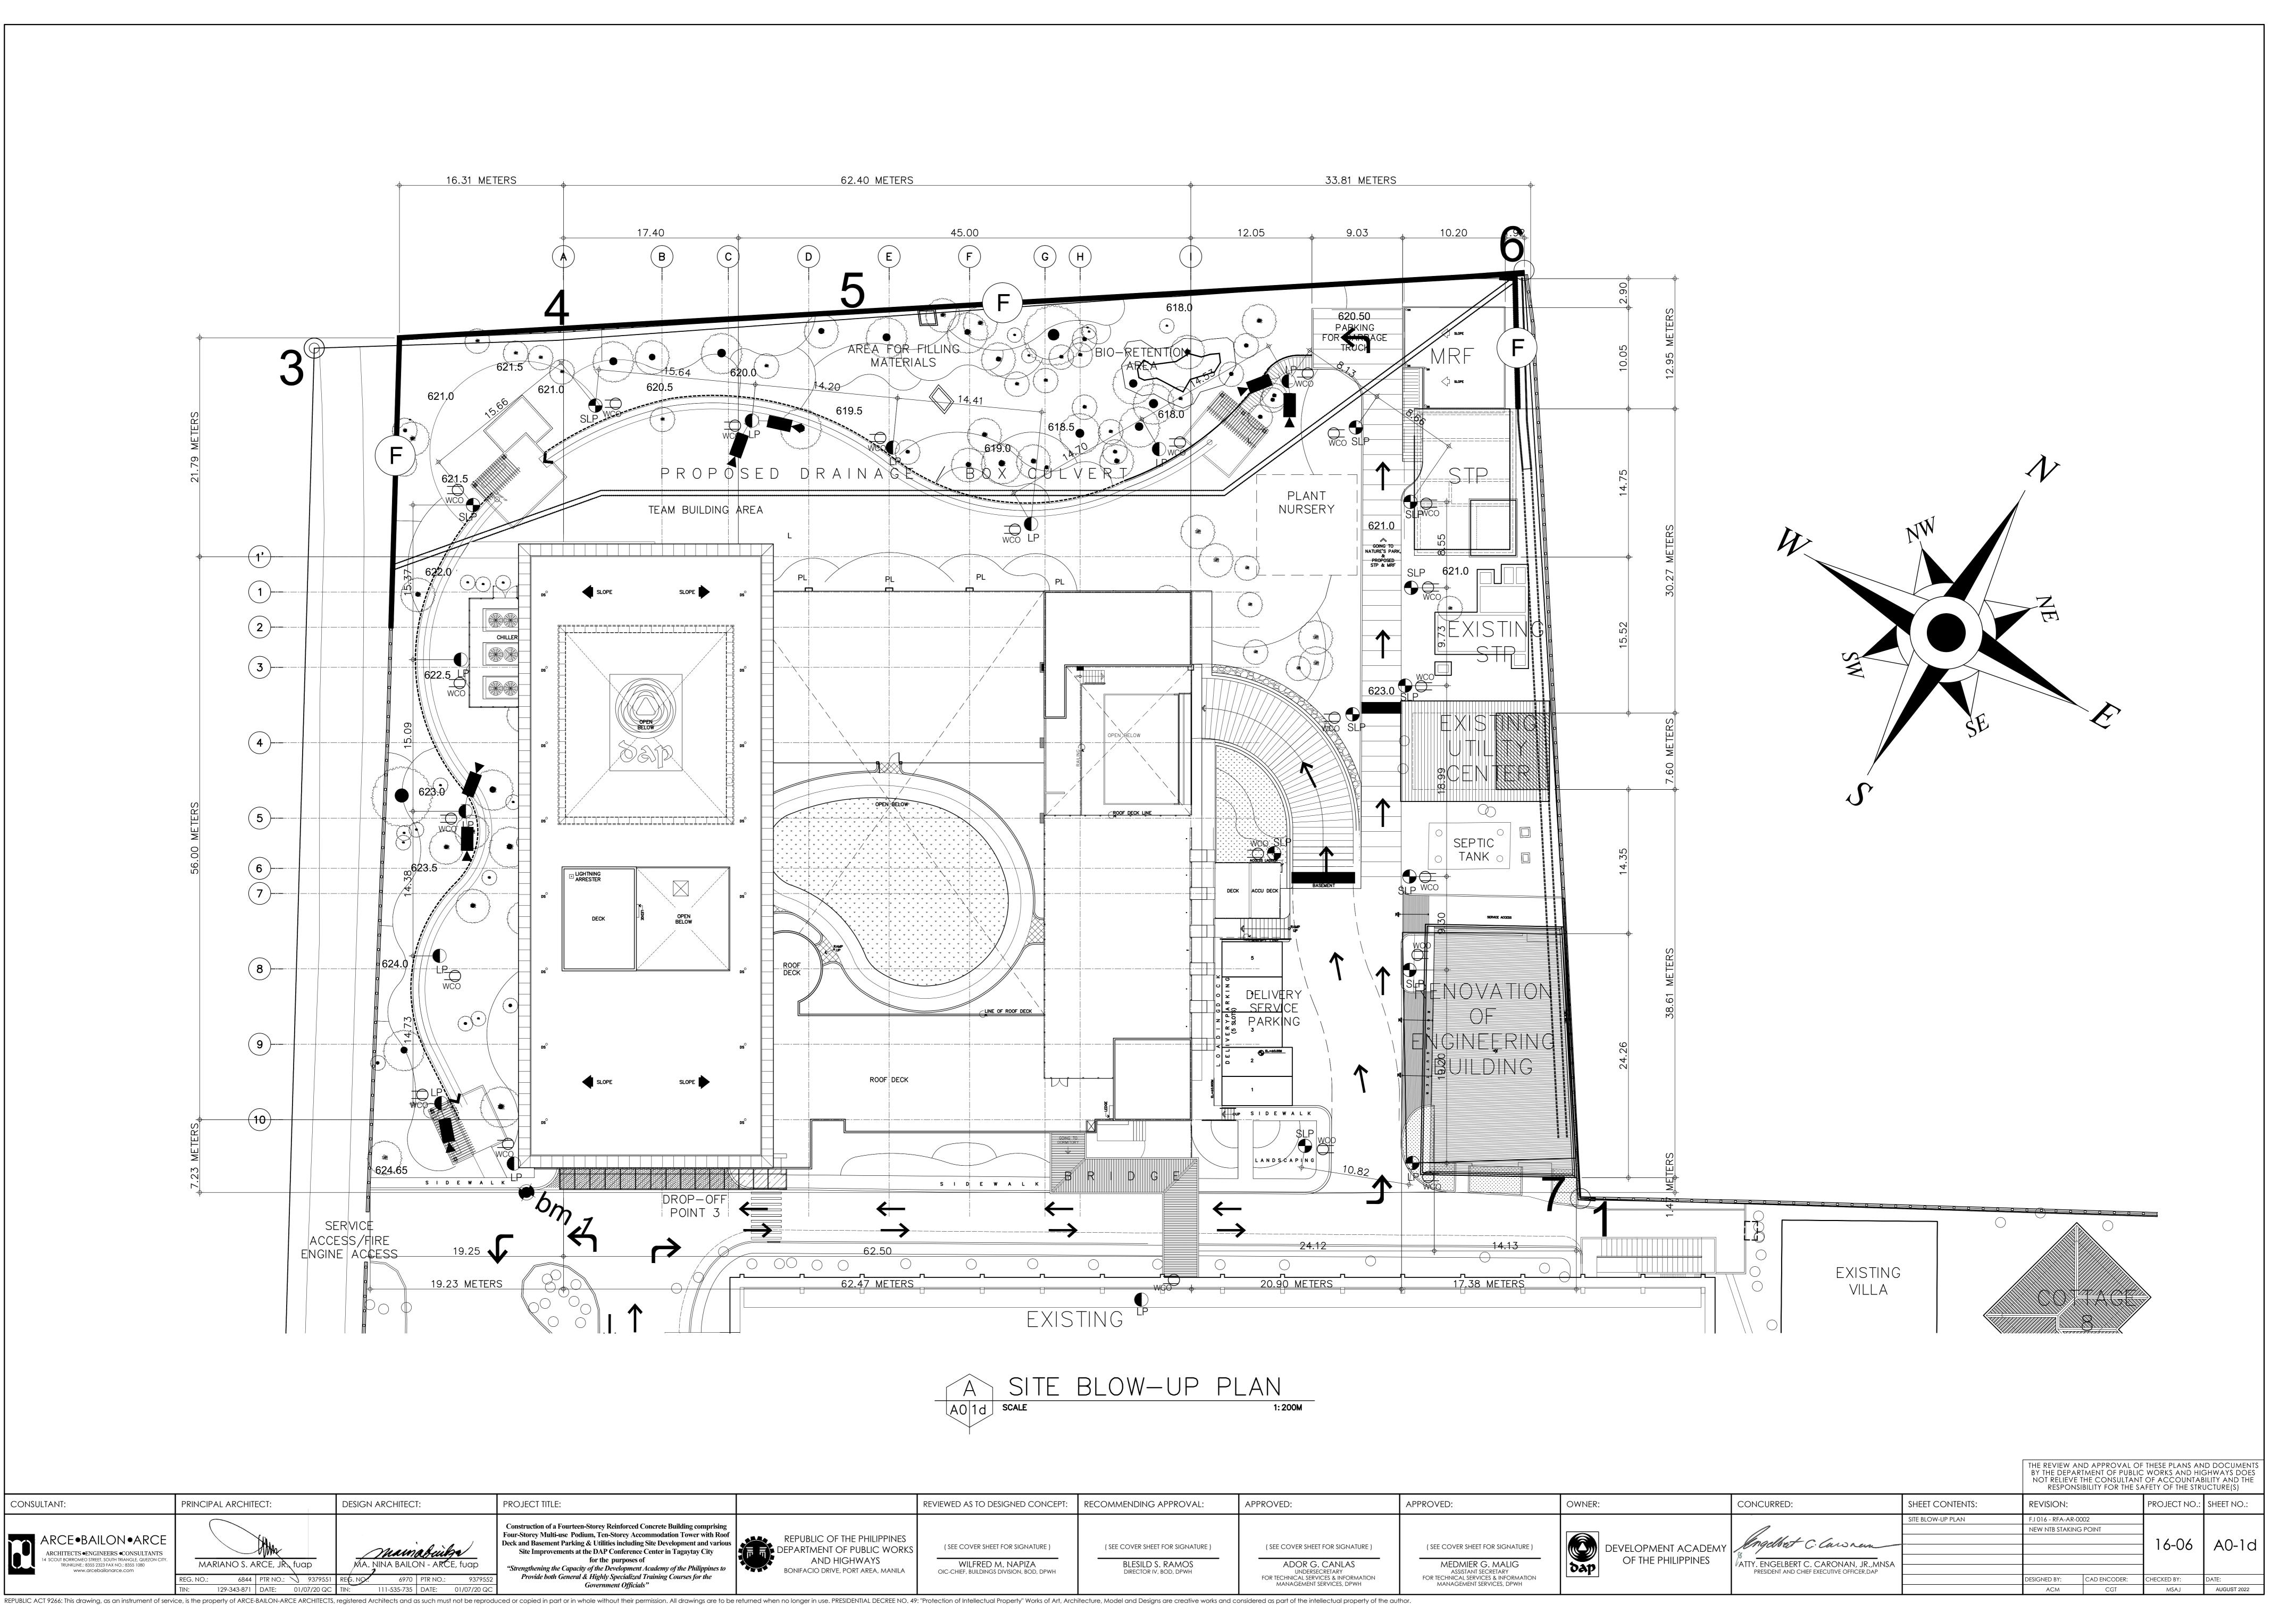


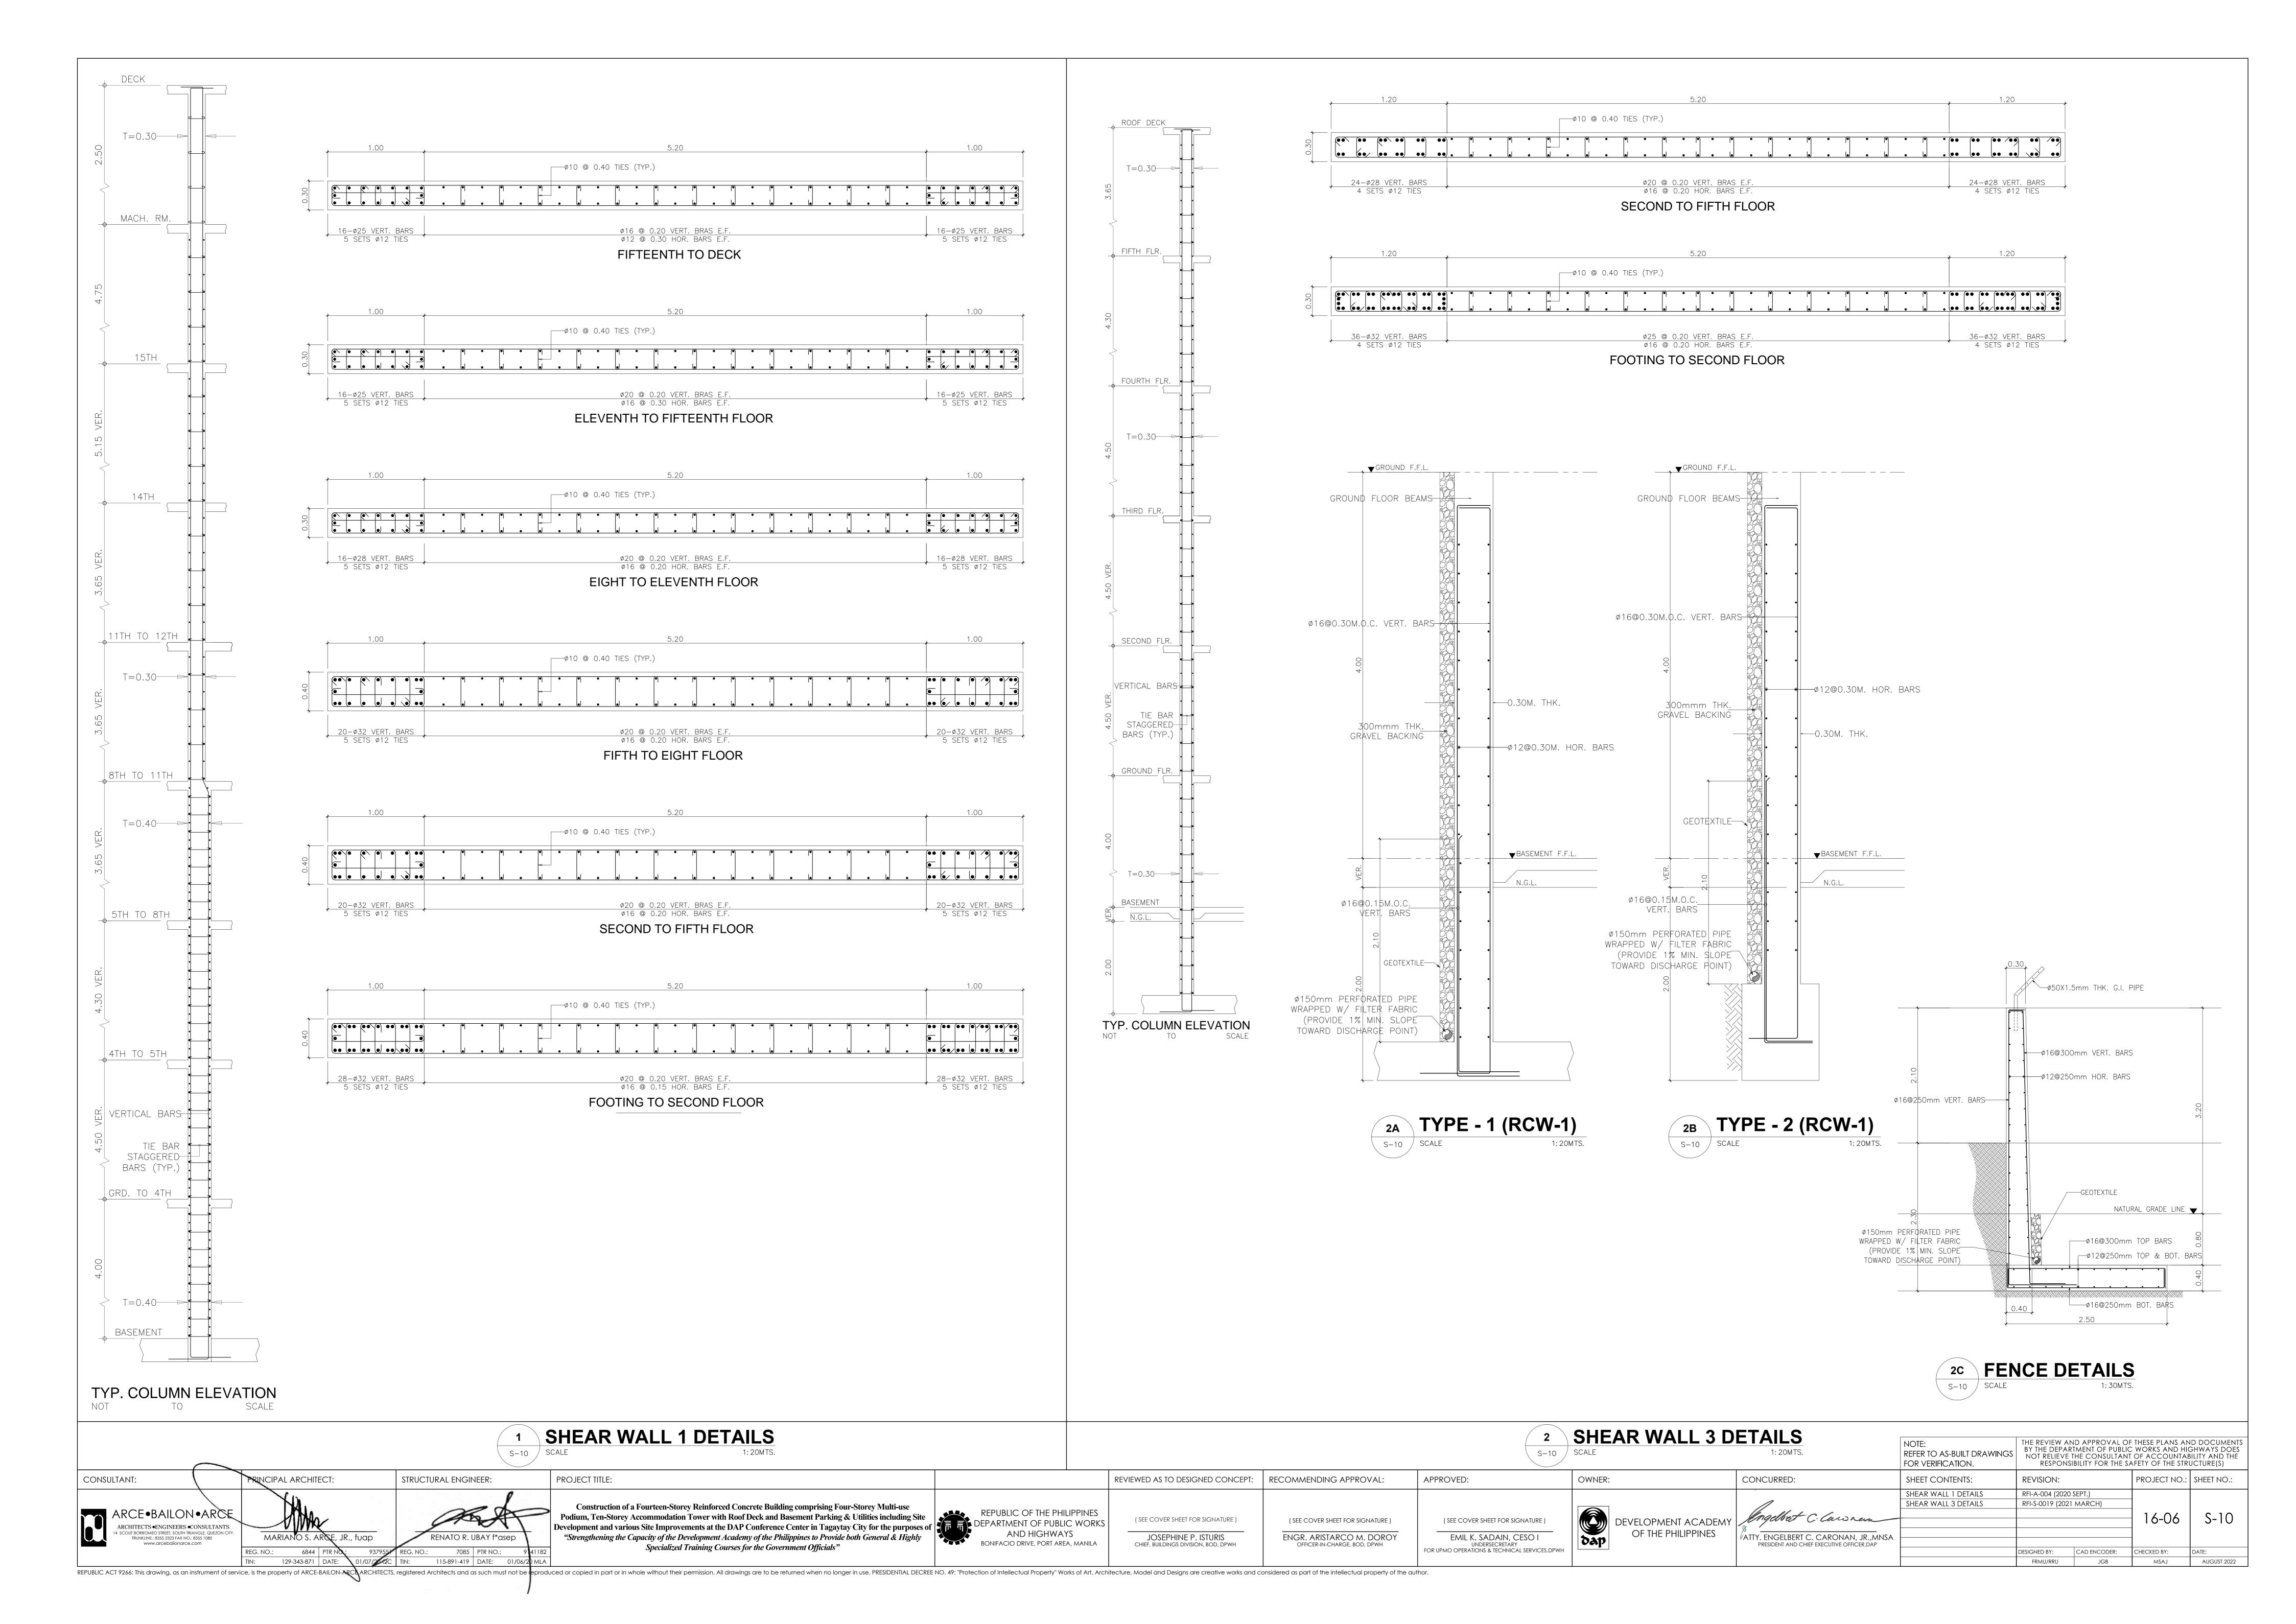

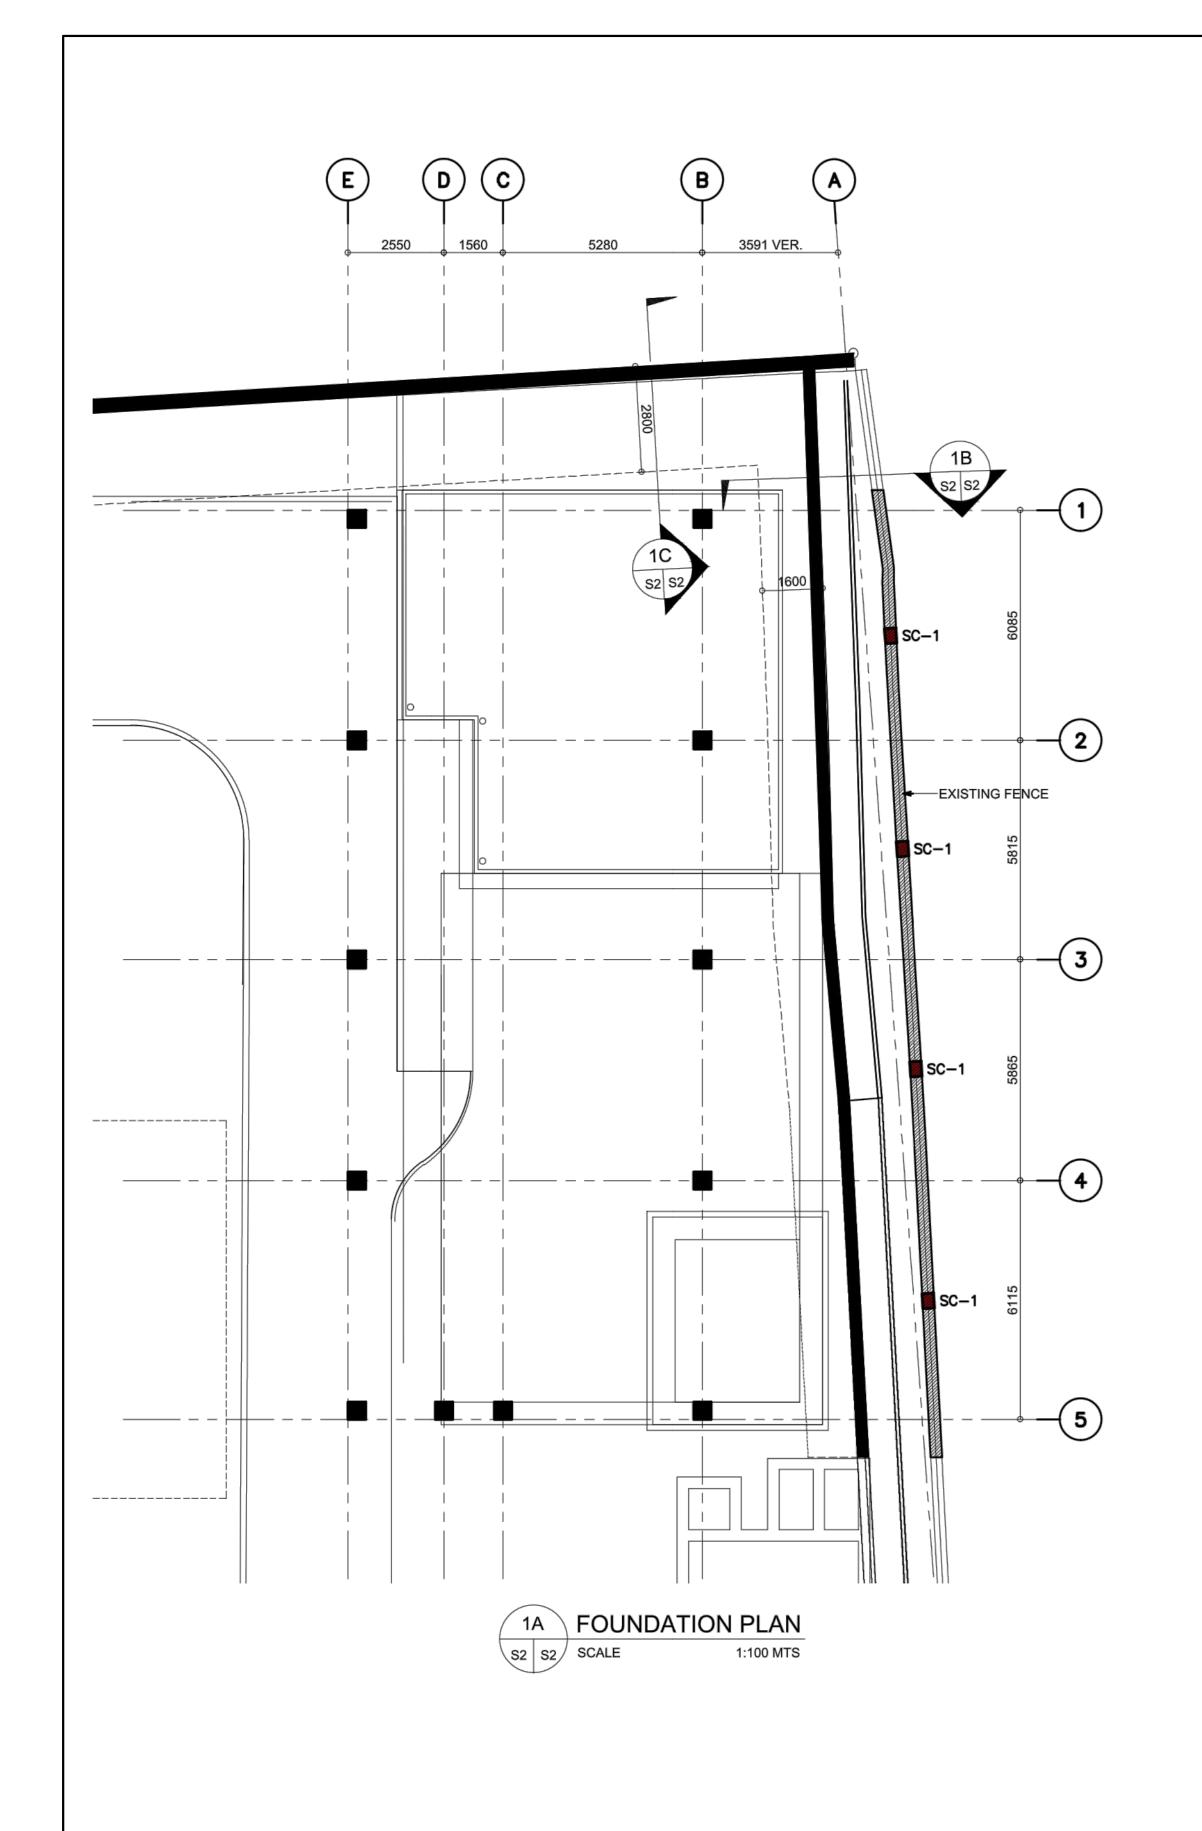

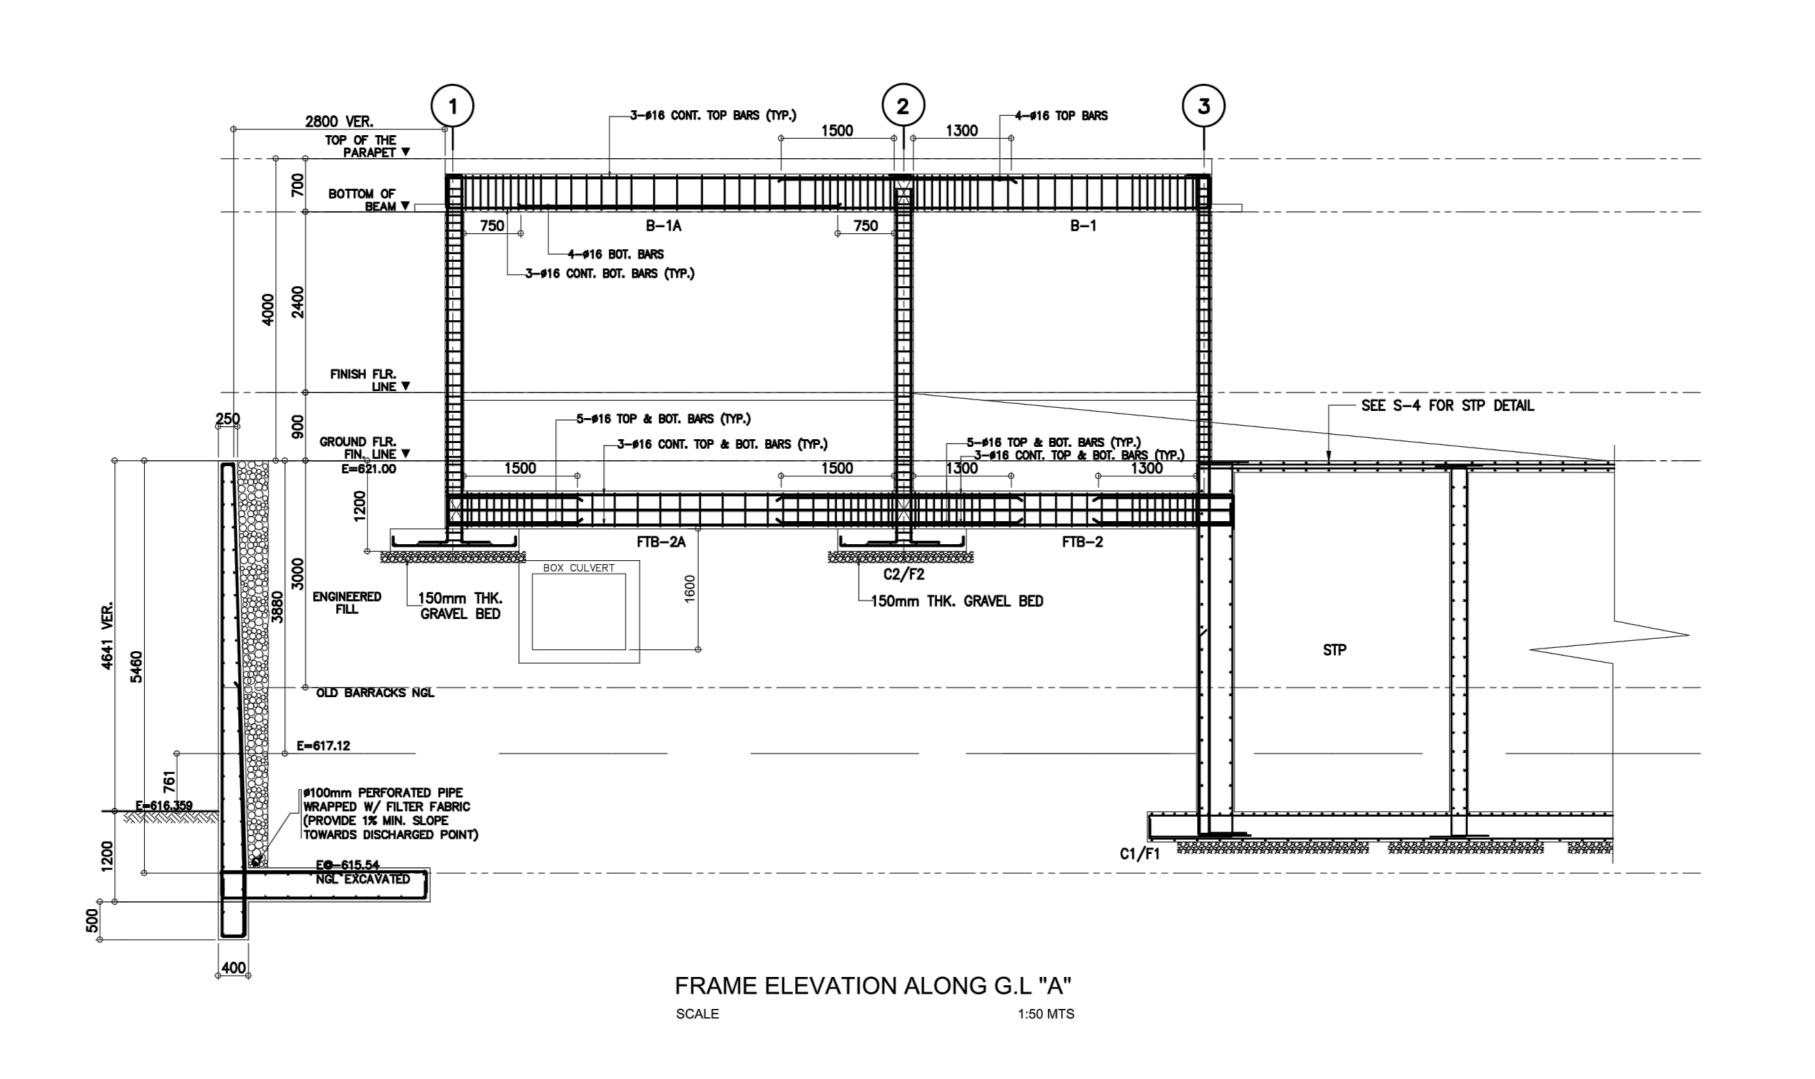

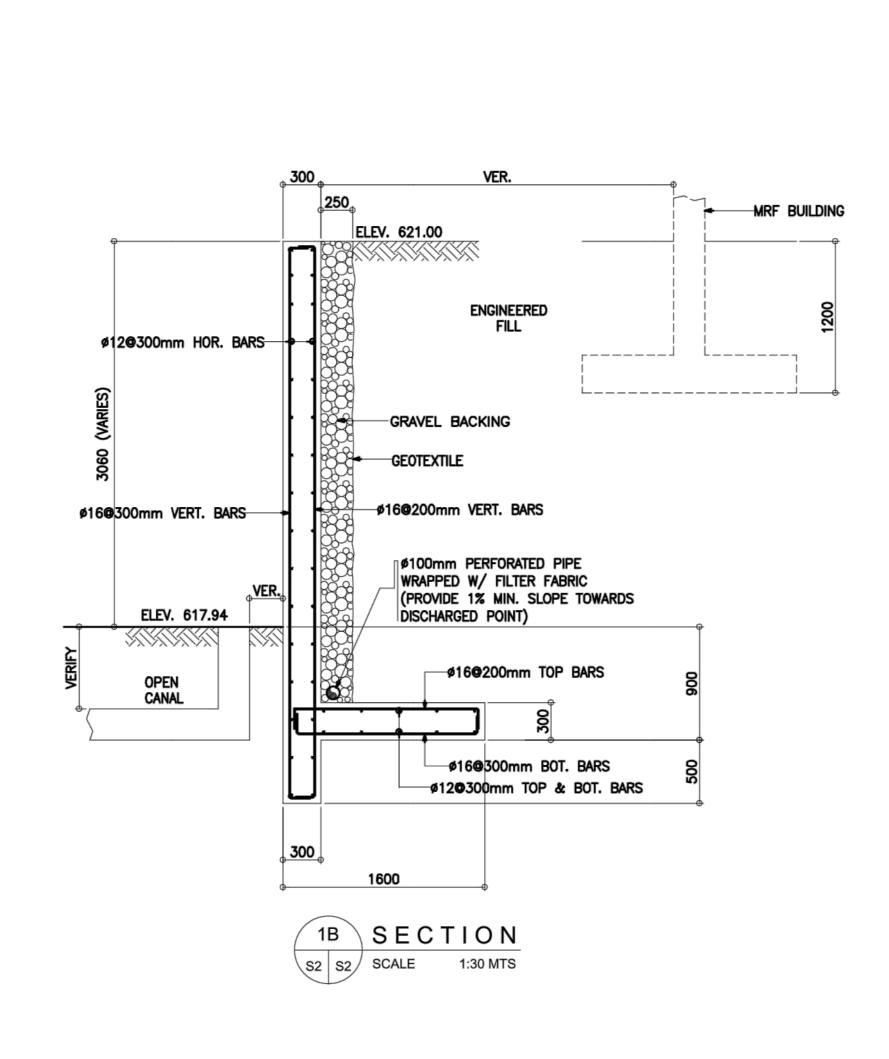

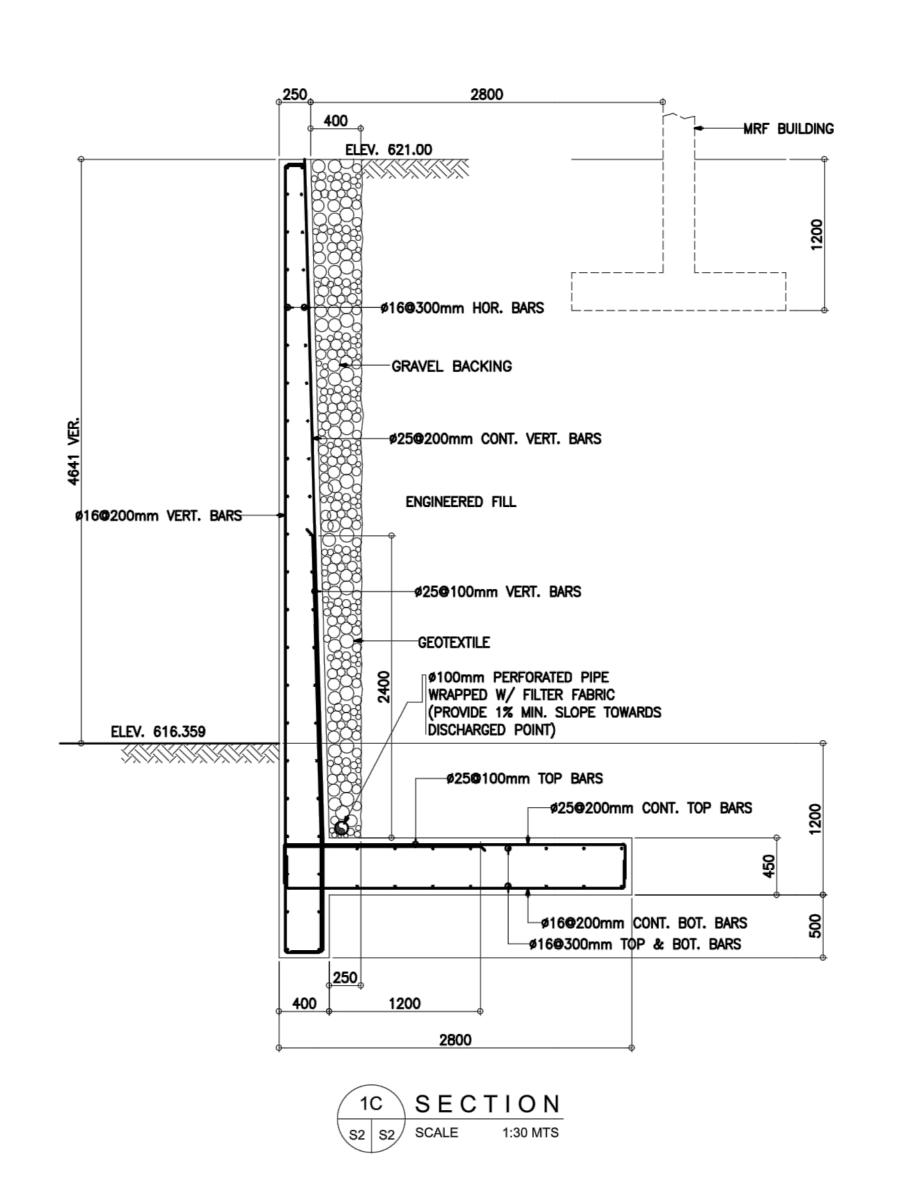

LEGEND:

WALL FOOTII

LL FOOTING ____

1 PERIMETER FENCE LAYOUT & DETAILS
1: 150MTS.

CONSULTANT:	PRINCIPAL ARCHITECT:	STRUCTURAL ENGINEER:	PROJECT TITLE:	REVIEWED AS TO DESIGNED CONCEPT:	RECOMMENDING APPROVAL:	APPROVED:	APPROVED:	OWNER:	CONCURRED:	SHEET CONTENTS:	REVISION:	PROJECT NO.: SHEET NC
ARCE BAILON ARCE ARCHITECTS ENGINEERS CONSULTANTS 14 SCOUT BORROMEO STREET, SOUTH TRIANGLE, QUEZON CITY. TRUNKLINE: 8355 2323 FAX NO.: 8355 1080 www.arcebailonarce.com	MARIANO S. ARCE, JR., fuap RENATO R. UBAY f*asep	Construction of a Fourteen-Storey Reinforced Concrete Building comprising Four-Storey Multi-use Podium, Ten-Storey Accommodation Tower with Roof Deck and Basement Parking & Utilities including Site Development and various Site Improvements at the DAP Conference Center in Tagaytay City for the purposes of "Strengthening the Capacity of the Development Academy of the Philippines to" REPUBLIC OF THE PHILIPPINES DEPARTMENT OF PUBLIC WORKS AND HIGHWAYS BONIFACIO DRIVE, PORT AREA, MANILA	(SEE COVER SHEET FOR SIGNATURE) WILFRED M. NAPIZA OIC-CHIEF, BUILDINGS DIVISION, BOD, DPWH	(SEE COVER SHEET FOR SIGNATURE) BLESILD S. RAMOS DIRECTOR IV, BOD, DPWH	(SEE COVER SHEET FOR SIGNATURE) ADOR G. CANLAS UNDERSECRETARY	(SEE COVER SHEET FOR SIGNATURE) MEDMIER G. MALIG ASSISTANT SECRETARY	DEVELOPMENT ACADEMY OF THE PHILIPPINES	ATTY. ENGELBERT C. CARONAN, JR., MNS PRESIDENT AND CHIEF EXECUTIVE OFFICER DAP	FERIMETER FENCE LAYOUT & DETAILS		16-06 S2-2	
	REG. NO.: 6844 PTR NO.: 9379 TIN: 129-343-871 DATE: 01/07/20	551 REG. NO.: 7085 PTR NO.: 9141182 QC TIN: 115-891-419 DATE: 01/06/20 MLA	Provide both General & Highly Specialized Training Courses for the Government Officials"	1		FOR TECHNICAL SERVICES & INFORMATION MANAGEMENT SERVICES, DPWH	FOR TECHNICAL SERVICES & INFORMATION MANAGEMENT SERVICES, DPWH				DESIGNED BY: CAD ENCODER FRMU/RRU JGB	ER: CHECKED BY: DATE: MSAJ